

## SCALE: 1/4"=1'-0'

FRAMING

FOUNDATION PLAN

## General Notes:

- All lumber shall be ground contact preservative treated wood UC4A or higher
- All connectors, anchors and fasteners shall be either Zmax or post batch hot-dip galvanized
- Provide double joists at center of the post or where I side of joist flush with face of post below to facilitate diagonal bracing connection.
- near the house basement wall, extend the footing down until reach the bearing capacity. Where the 1500 psf soil bearing pressure capacity of the footing is not obtained; usually
- A 3x3 wood placed under beam or double joists may be used in lieu of 2x4 diagonal bracing shown.

Beam splice at interior posts only.


## DECK FRAMING/ WOOD FOUNDATION PLAN AND **ELEVATIONS**




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Drawing No.



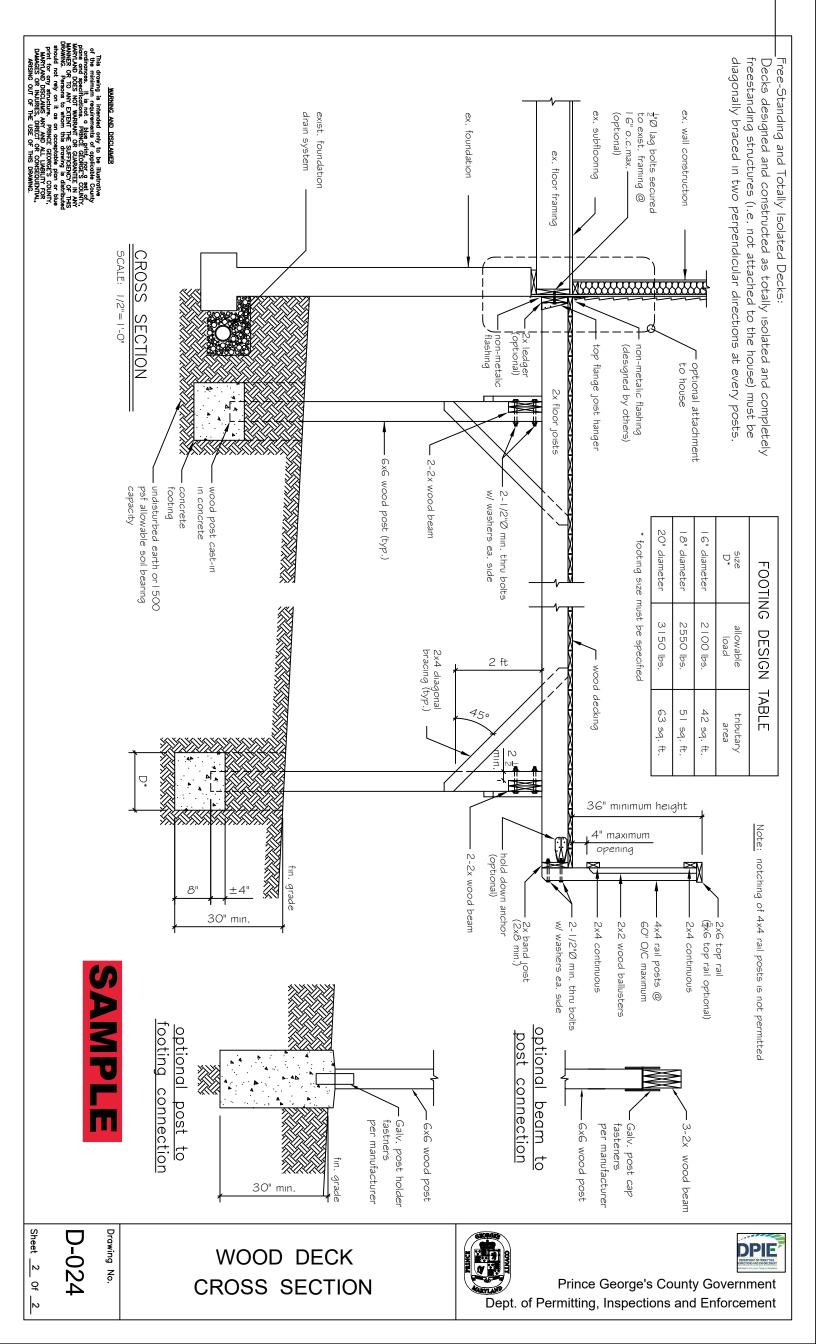

**ELEVATION AND** 

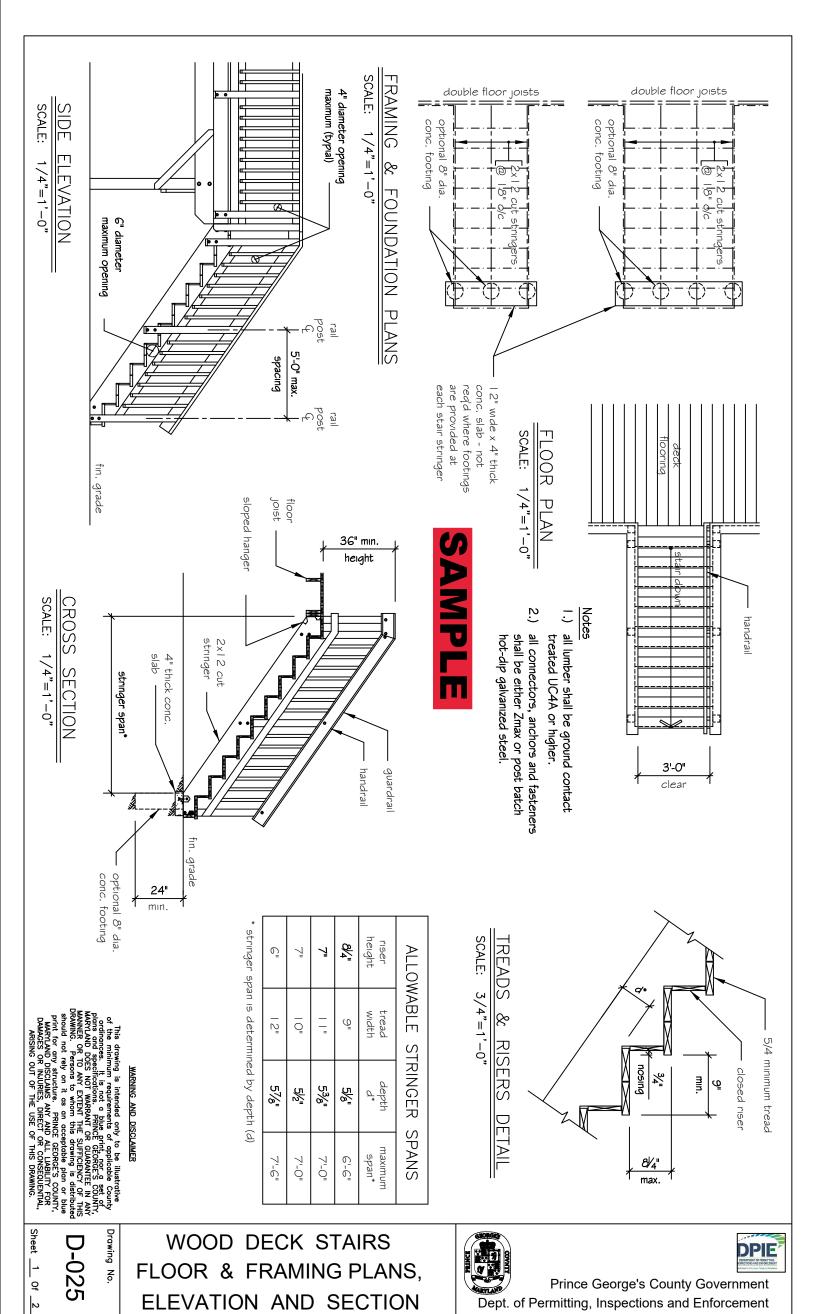SECTION

Dept. of Permitting, Inspections and Enforcement

