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REVISION 2 - RFI RESPONSE


08/14/2023

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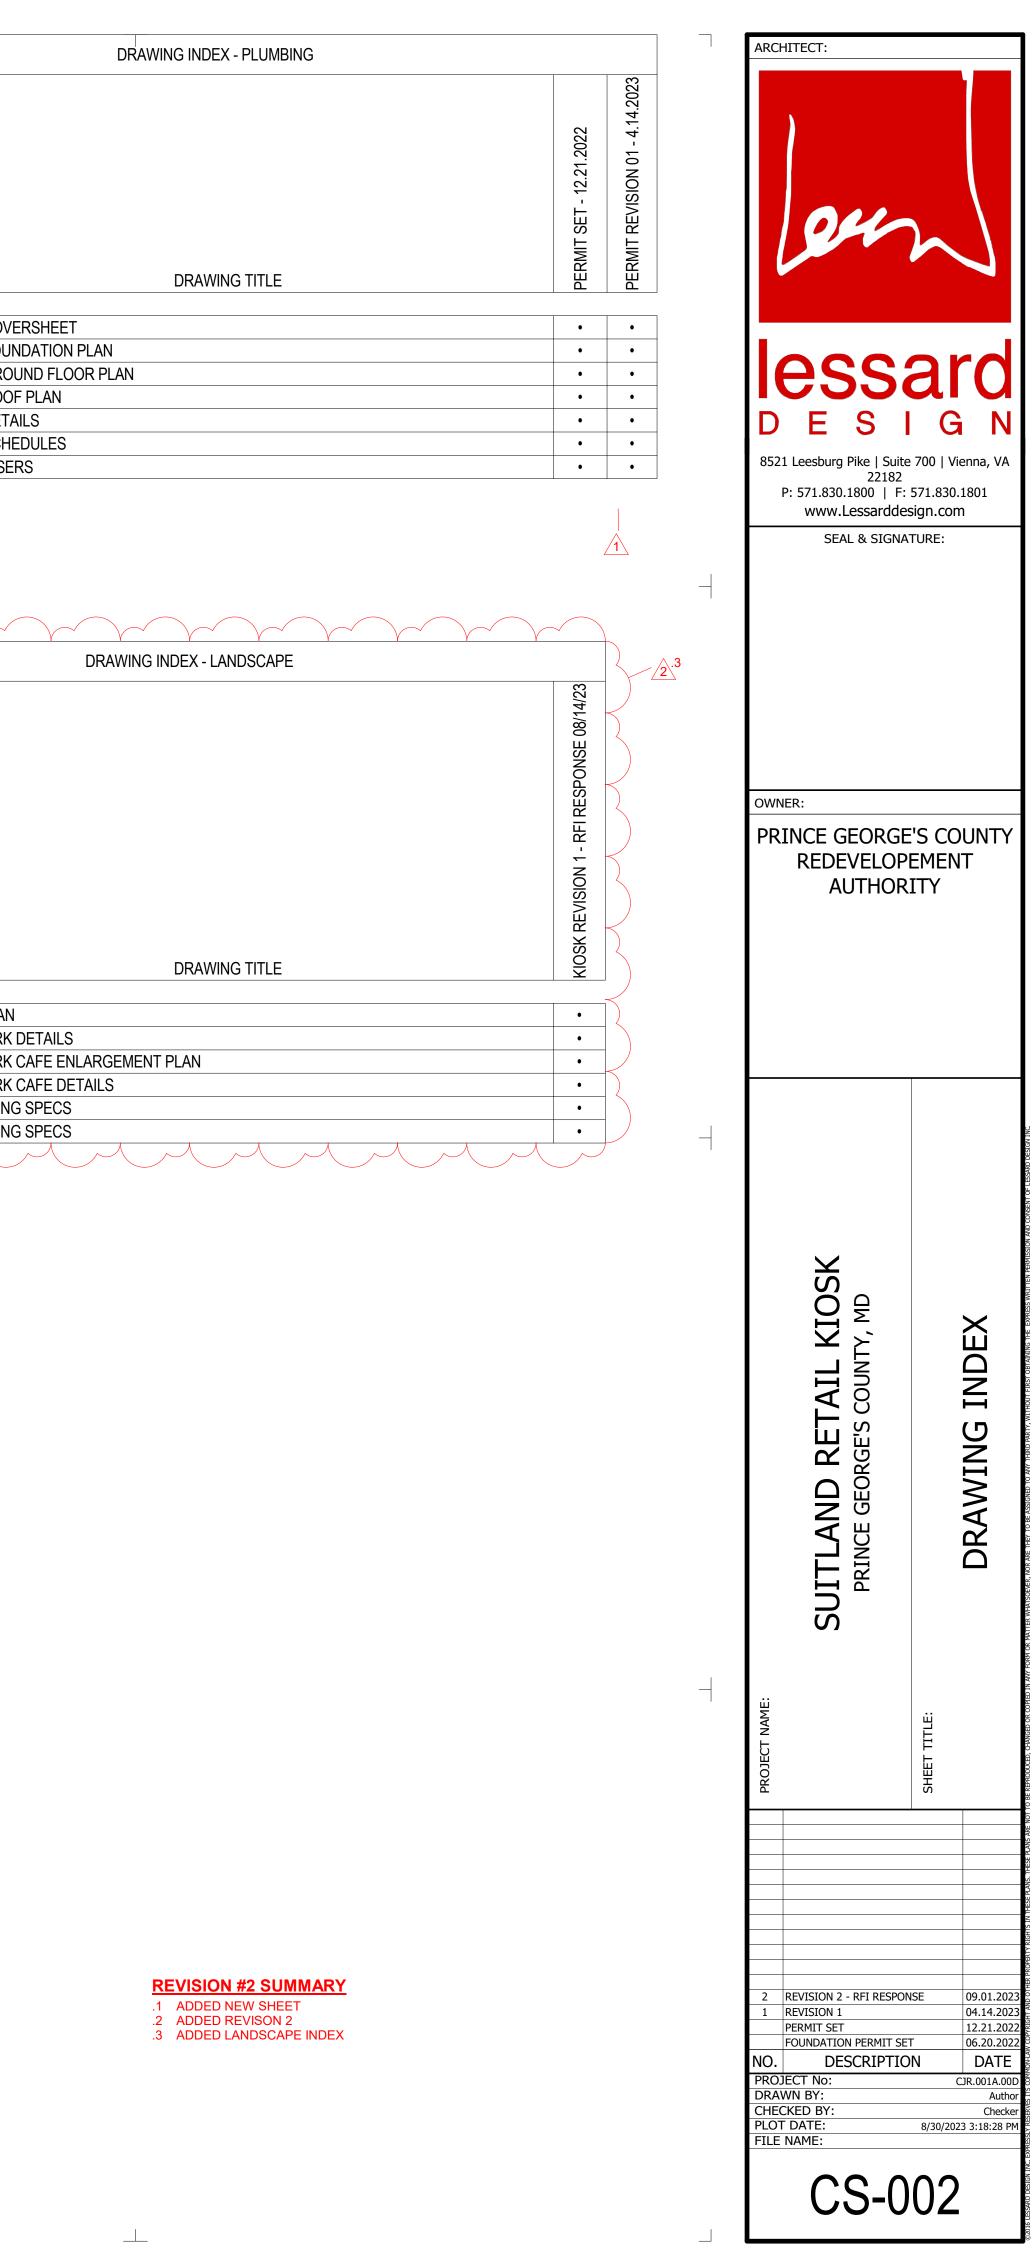
		DRAWING INDEX - COVER				\sim	2.2	DRAWING INDEX - STRUCTURE		
			FOUNDATION PERMIT SET	PERMIT SET - 12.21.2022	PERMIT REVISION 01 - 4.14.2023	REVISION 2 - RFI RESPONSE - 08.14.2023	SHEET NO.	DRAWING TITLE	PERMIT SET - 12.21.2022	PFRMIT REVISION 01 - 4 14 2023
SHEET NO		DRAWING TITLE		ER			S-001	GENERAL NOTES & DETAILS	•	•
ONLETINO							S-100	FOUNDATION PLAN	•	•
-001	COVER SHEET		•	•		•	S-200	CANOPY FRAMING PLAN	•	•
002	DRAWING INDEX		•	•	•	•	S-210	ROOF FRAMING PLAN	•	•
JUZ	DRAWING INDEX		•	•	•	•	S-401	CONCRETE DETAILS	•	•
				/			S-501	STEEL DETAILS	•	•
							S-502	COLD FORMED STEEL DETAILS	•	•
							S-503	STEEL DETAILS	•	•
							S-504	STEEL DETAILS	•	•

	DRAWING INDEX - GENERAL					2		DRAWING INDEX - MECHANICAL				
SHEET NO.	DRAWING TITLE	FOUNDATION PERMIT SET	PERMIT SET - 12.21.2022	PERMIT REVISION 01 - 4.14.2023	REVISION 2 - RFI RESPONSE - 08.14.2023		SHEET NO. M-001 M-002	DRAWING TITLE MECHANICAL COVER SHEET MECHANICAL NOTES	PERMIT SET - 12.21.2022 PERMIT REVISION 01 - 4.14.2023		SHEET NO.	
G-001	GRAPHIC STANDARDS, ABBREVIATIONS, VICINITY MAP, GENERAL NOTES		•		•		M-101	MECHANICAL GROUND FLOOR PLAN	• •	_	GHEET NO.	•
G-011	CODE ANALYSIS		•		•	-	M-102	MECHANICAL ROOF PLAN	• •	_	► L-301	PLANTING PLAN
G-012	GROUND FLOOR LIFE SAFETY PLAN		•		•	-	M-501	MECHANICAL DETAILS	• •	_ (L-506C	CENTRAL PARK DE
G-020	COMCHECK ENVELOPE COMPLIANCE		•		•		M-601	MECHANICAL SCHEDULES	• •	_	L-530	CENTRAL PARK CA
G-024	ADA ACCESSIBILITY REQUIREMENTS		•		•		M-701	MECHANICAL REPORTS	• •		L-531	CENTRAL PARK CA
G-030	WALL, FLOOR AND ROOF ASSEMBLIES		•		•	-	M-801	MECHANICAL CALCULATIONS	• •		L-901	KIOSK PLANTING S
G-046	TYPICAL FLASHING DETAILS		•		•	-			\sim) (L-902	KIOSK PLANTING S
		ii				-			L	1		

	DRAWING INDEX - ARCHITECTURE					DRAWING INDEX - ELECTRICAL		
		FOUNDATION PERMIT SET	MIT SET - 12.21.2022	PERMIT REVISION 01 - 4.14-2023 REVISION 2 - RFI RESPONSE - 08.14.2023	SHEET NO.	DRAWING TITLE	PERMIT SET - 12.21.2022	DERMIT REVISION 01 - 4 14 2023
SHEET NO.	DRAWING TITLE	Ino	PERMIT	EVI SEVI	E-001	ELECTRICAL COVERSHEET	•	
0.1227.1101					E-101	ELECTRICAL GROUND FLOOR PLAN	•	_
A-001	ARCHITECTURAL SITE PLAN	•	•	•	E-102	ELECTRICAL ROOF PLAN	•	
A-101	GROUND FLOOR PLAN	•	•	•	E-501	ELECTRICAL SYMBOLS, ABBREVIATIONS & DETAILS	•	_
A-102	GROUND SLAB PLAN	•	•	•	E-502		•	_
A-131	GROUND FLOOR RCP		•	•	E-601	ELECTRICAL POWER RISER	•	
A-141	ROOF PLAN AND DETAILS		•	•	E-602		•	
A-211	ELEVATIONS		•	•	E-603	ELECTRICAL LIGHTING FIXTURE SCHEDULES & COMPLIANCE CERTIFICATE	•	
A-212	COLORED ELEVATIONS		•	•				
A-213	PERSPECTIVE VIEWS		•	•				
A-301	BUILDING SECTIONS		•	•				
A-311	WALL SECTIONS		•	•				
A-312	WALL SECTIONS		•	•				
A-313	WALL SECTIONS		•	•				
A-314	WALL SECTIONS			•				
A-401	RESTROOM ENLARGED PLANS AND ELEVATIONS		•	•				
A-402	CANOPY DETAILS		•	•				
A-403	SEATING AREA ENTRANCE PLANS AND ELEVATIONS		•	•				
A-404	SEATING AREA ENTRANCE DETAILS			•				
A-501	TYPICAL DETAILS		•	•				
A-502	TYPICAL DETAILS		•	•				
A-601	SCHEDULE AND DETAILS		•	• •				

SHEET NO.

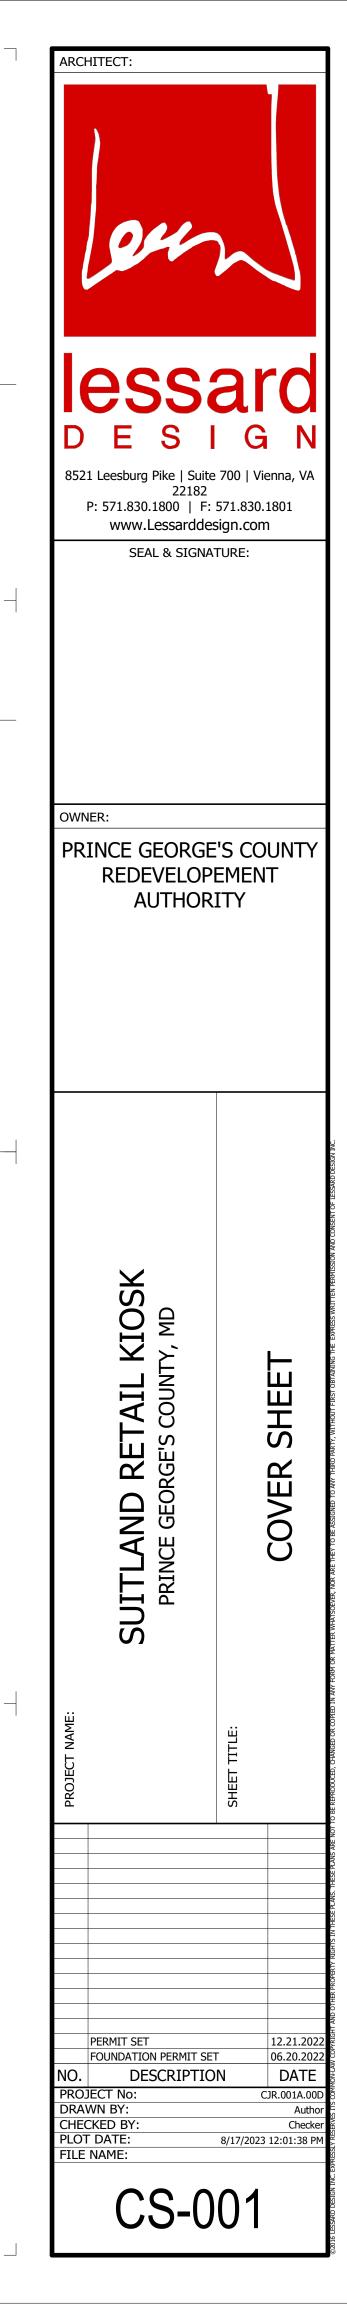P-001	PLUMBING COVE
P-100	PLUMBING FOUN
P-101	PLUMBING GRO
P-102	PLUMBING ROO
P-501	PLUMBING DETA
P-601	PLUMBING SCHE
P-611	PLUMBING RISE



ABBREVIATIONS

A/E	ARCHITECT/ENGINEER*	EP	EDGE OF PAVEMENT*
AB	ANCHOR BOLT	EP	ELECTRICAL PANEL*
ABC	AGGREGATE BASE COURSE*	EQL SP	EQUALLY SPACED
ABRSV	ABRASIVE	EQUIP	EQUIPMENT*
ABV	ABOVE	EQUIV	EQUIVALENT
	AIR CONDITIONING	ESMT	EASEMENT*
ACOUS	ACOUSTICAL*	EW	EACH WAY
ACOUS INSUL	ACOUSTICAL INSULATION	EXH	EXHAUST
ACR PL	ACRYLIC PLASTIC*	EXH FN	EXHAUST FAN*
AD	ACCESS DOOR*	EXH GR	EXHAUST GRILLE*
AD	AREA DRAIN	EXH HD	EXHAUST HOOD*
ADDL	ADDITIONAL*	EXH RG	EXHAUST REGISTER*
ADDM	ADDENDUM*	EXP	EXPANSION
ADH	ADHESIVE	EXP BT	EXPANSION BOLT*
ADJ ADJC	ADJUSTABLE ADJACENT*	EXP JT EXST	EXPANSION DOLT EXPANSION JOINT EXISTING
AFF AFG	ABOVE FINISH FLOOR* ABOVE FINISH GRADE*	EXT	EXTERIOR
AFS	ABOVE FINISH SLAB*	F BRK	
AGGR	AGGREGATE	FF	FINISH TO FINISH
AL	ALUMINUM	FB	FIRE BLANKET*
ALT NO	ALTERNATE NUMBER*	FB	FLAT BAR
ANOD	ANODIZED*	FBD	FIBERBOARD*
ANT	ANTENNA	FD	FLOOR DRAIN
AP	ACCESS PANEL	FDN	FOUNDATION
APT	APARTMENT	FEXT	FIRE EXTINGUISHER
ARCH	ARCHITECT (URAL)	FFA	FROM FLOOR ABOVE*
ASC	ABOVE SUSPENDED CEILING*	FFB	FROM FLOOR BELOW
ASPH	ASPHALT	FGL	FIBERGLASS
ASSY	ASSEMBLY	FHY FIN	FIRE HYDRANT FINISH*
B	BATHROOM*	FIN FL	FINISH FLOOR*
B/B	BACK TO BACK*	FIN GR	FINISH GRADE
BAF	BAFFLE	FL	FLASHING
BB	BASEBOARD*	FLDG	FOLDING
BC	BACK OF CURB*	FLG	FLANGE
BD	BOARD	FLR	FLOOR (ING)*
BETW	BETWEEN	FLR FIN	FLOOR FINISH
BEV	BEVEL	FLR PL	FLOOR PLATE*
BF	BOTH FACES*	FLR REG	FORMBOARD
BF	BOTTOM FACES	FMBD	
BITUM	BITUMINOUS	FN	FLOOR PLATE*
BL	BASE LINE		FENCE*
BLDG	BUILDING	FOC FOF	FACE OF CONCRETE* FACE OF FINISH*
BLK	BLOCK	FOM	FACE OF MASONRY*
BLKG	BLOCKING	FOS	FACE OF STUDS*
BLW CLG	BELOW CEILING*	FPL	FIREPLACE*
BLW FFLR	BELOW FINISH FLOOR*	FPRF	FIREPROOFING
BM	BEAM	FR	FIRE RATING*
BM	BENCH MARK	FSTNER	FASTENER
BOT	BOTTOM	FTG	FOOTING
BP	BASE PLATE	FUR	FURNACE
BR	BEDROOM	FURR	FURRING*
BRCG	BRACING*	FUT	FUTURE
BRDG	BRIDGING*	FWC	FABRIC WALL COVERING*
BRDG JST	BRIDGING JOIST*	FXTR	
BRG BRG PL	BEARING BEARING PLATE*	G	GAS
BRK BRKT	BRICK BRACKET	GA	GAGE
BS	BOTH SIDES	GAL GALV	GALLON GALVANIZED
BSMT	BASEMENT	GALVS	GALVANIZED STEEL
BU	BUILT-UP*	GB	GRAB BAR*
BUR	BUILT-UP ROOF*	GD	GUTTER DRAIN*
BW	BOTH WAYS	GDR	GUARD RAIL
C/C	CENTER TO CENTER*	GEN GENL CONTR	GENERATOR GENERAL CONTRACT
CAB	CABINET	GIP	GALVANIZED IRON PIPE*
CEM	CEMENT	GL	GLASS
CER TILE	CERAMIC TILE*	GL BLK	GLASS BLOCK*
CFLG	COUNTER FLASHING	GLU LAM	GLUE LAMINATED*
CHAN	CHANNEL	GLZ	GLAZING
CHFR	CHAMFER*	GLZ CMU	GLAZFD CONCRETE
CI	CAST IRON	GR BM	MASONRY UNIT*
CIP	CAST IRON PIPE		GRADE BEAM*
CJ	CONSTRUCTION JOINT	GRL	GRILLE
CL	CENTER LINE	GRTG	GRATING
CLG	CEILING	GSKT	GASKET
CLG HT		GSNK	GOOSENECK*
CLG REG	CEILING HEIGHT CEILING REGISTER	GT GUT	GROUT*
CLJ	CONTROL JOINT	GVL	GUTTER
CLO	CLOSET		GRAVEL
CMU	CONCRETE MASONRY UNIT	GYP	GYPSUM
CNTR	COUNTER	GYP BD	GYPSUM BOARD*
CO COL	CASED OPENING* COLUMN	НА	HANDICAPPED-ACCESSIBLE
CONC	CONCRETE	HB	HOSE BIB
CONC FL	CONCRETE FLOOR*	HC	HOLLOW CORE*
COND	CONDENSER (ATE)_	HC	HANDICAPPED
CONN	CONNECTION	HCMU	HOLLOW CONCRETE
CONSTR	CONSTRUCTION CONTINUOUS (ATION)	HDBD	MASONRY UNIT* HARDBOARD*
CONTR	CONTRACT (OR)	HDR	HEADER
	COORDINATE	HDWD	HARDWOOD*
CORR	CORRIDOR*	HDWE	HARDWARE*
CPA	COMPACTOR	HEX	HEXAGONAL
CPA CRN CS	COMPACTOR CROWN CAST STONE	HGR HGT	HANGER HEIGHT
CSB	CASING BEAD*	HM	HOLLOW METAL
CSB	CONCRETE SPLASH BLOCK	HMD	HOLLOW METAL DOOR*
CSG	CASING	HMF	HOLLOW METAL FRAME
CSK	COUNTERSUNK*	HNDRL	HANDRAIL
CSMT	CASEMENT*	HORIZ	HORIZONTAL
CSWK	CASEWORK*	HVAC	HEATING, VENTILATION, AIR
CTV	CABLE TELEVISION*	HWH	HOT WATER HEATER
		ICC ID	IMPACT INSULATION CLASS
DBL ACT DBL GLZ	DOUBLE ACTING DOUBLE GLAZING	IF	INSIDE FACE*
DCL	DOOR CLOSURE	INL	INLET
DEMO	DEMOLITION*	INSTL	INSTALLATION
DET	DETAIL	INSUL	INSULATION
DF	DRINKING FOUNTAIN	INSUL PNL	INSULATION PANEL*
DFR	DOOR FRAME*	INTERCOM	INTERCOMMUNICATION
DH	DOUBLE HUNG	INTR	INTERIOR
DIFF	DIFFERENCE	INVL EL	INVERT ELEVATION*
DIM	DIMENSION	IP	IRON PIPE
DJ DL	DOUBLE JOIST* DEAD LOAD	ISO	ISOMETRIC
DLV	DOOR LOUVER	JC	JANITOR'S CLOSET
DMPF	DAMPPROOFING	JST	JOIST*
DN	DOWN	JT	JOINT
DO		KIT	KITCHEN*
DR DR			
	DITTO DINING ROOM	KOP	KNOCKOUT PANEL
DRW	DITTO DINING ROOM DRAIN DRY WELL*	KOP LAU	KNOCKOUT PANEL
DRW DS DSP	DITTO DINING ROOM DRAIN DRY WELL* DOWNSPOUT DRY STANDPIPE*	KOP LAU LAV LB	KNOCKOUT PANEL LAUNDRY LAVATORY POUND
DRW DS DSP DST DT	DITTO DINING ROOM DRAIN DRY WELL* DOWNSPOUT DRY STANDPIPE* DOOR STOP DRAIN TILE	KOP LAU LAV LB LBL LBR	KNOCKOUT PANEL LAUNDRY LAVATORY POUND LABEL LUMBER
DRW DS DSP DST DT DVTL DW	DITTO DINING ROOM DRAIN DRY WELL* DOWNSPOUT DRY STANDPIPE* DOOR STOP DRAIN TILE DOVETAIL DISHWASHER	KOP LAU LAV LB LBL LBR LD BRG LDG	KNOCKOUT PANEL LAUNDRY LAVATORY POUND LABEL LUMBER LOAD BEARING* LANDING
DRW DS DSP DST DT DVTL DW DWG DWL	DITTO DINING ROOM DRAIN DRY WELL* DOWNSPOUT DRY STANDPIPE* DOOR STOP DRAIN TILE DOVETAIL DISHWASHER DRAWING DOWEL	KOP LAU LAV LB LBL LBR LD BRG LDG LDR LF	KNOCKOUT PANEL LAUNDRY LAVATORY POUND LABEL LUMBER LOAD BEARING* LANDING LEADER LINEAR FOOT*
DRW DS DSP DST DT DVTL DW DWG	DITTO DINING ROOM DRAIN DRY WELL* DOWNSPOUT DRY STANDPIPE* DOOR STOP DRAIN TILE DOVETAIL DISHWASHER DRAWING	KOP LAU LAV LB LBL LBR LD BRG LDG LDG LDR LF LNGE LH	KNOCKOUT PANEL LAUNDRY LAVATORY POUND LABEL LUMBER LOAD BEARING* LANDING LEADER LINEAR FOOT* LOUNGE LEFT HAND
DRW DS DSP DST DT DVTL DW DWG DWL DWR	DITTO DINING ROOM DRAIN DRY WELL* DOWNSPOUT DRY STANDPIPE* DOOR STOP DRAIN TILE DOVETAIL DISHWASHER DRAWING DOWEL DRAWER	Kop Lau Lav Lb Lbr Ldbr Ldg Ldg Ldr Lf Lnge Lh Lhr Lhr Lin	KNOCKOUT PANEL LAUNDRY LAVATORY POUND LABEL LUMBER LOAD BEARING* LANDING LEADER LINEAR FOOT* LOUNGE LEFT HAND LEFT HAND REVERSE* LINEAR
DRW DS DSP DST DT DVTL DW DWG DWL DWR DWR DX E ECR	DITTO DINING ROOM DRAIN DRY WELL* DOWNSPOUT DRY STANDPIPE* DOOR STOP DRAIN TILE DOVETAIL DISHWASHER DRAWING DOWEL DRAWER DUPLEX EAST ELEVATOR CONTROL ROOM	KOP LAU LAV LB LBL LBR LD BRG LDG LDG LDR LF LNGE LH LHR	KNOCKOUT PANEL LAUNDRY LAVATORY POUND LABEL LUMBER LOAD BEARING* LANDING LEADER LINEAR FOOT* LOUNGE LEFT HAND LEFT HAND REVERSE*
DRW DS DSP DST DT DVTL DW DWG DWL DWR DWR DX	DITTO DINING ROOM DRAIN DRY WELL* DOWNSPOUT DRY STANDPIPE* DOOR STOP DRAIN TILE DOVETAIL DISHWASHER DRAWING DOWEL DRAWER DUPLEX EAST ELEVATOR CONTROL ROOM EACH FACE EXTERIOR INSULATION	KOP LAU LAV LB LBL LBR LD BRG LDG LDG LDR LF LNGE LH LHR LHR LIN LKR KR RM LL	KNOCKOUT PANEL LAUNDRY LAVATORY POUND LABEL LUMBER LOAD BEARING* LANDING LEADER LINEAR FOOT* LOUNGE LEFT HAND LEFT HAND REVERSE* LINEAR LOCKER
DRW DS DSP DST DT DVTL DW DWG DWL DWR DWR DX E ECR EF EIFS EL	DITTO DINING ROOM DRAIN DRY WELL* DOWNSPOUT DRY STANDPIPE* DOOR STOP DRAIN TILE DOVETAIL DISHWASHER DRAWING DOWEL DRAWER DUPLEX EAST ELEVATOR CONTROL ROOM EACH FACE EXTERIOR INSULATION FINISH SYSTEM EASEMENT LINE*	KOP LAU LAV LB LBR LD BRG LDG LDR LF LNGE LH LHR LHR LIN LKR LKR RM LL LNTL LONG	KNOCKOUT PANEL LAUNDRY LAVATORY POUND LABEL LUMBER LOAD BEARING* LANDING LEADER LINEAR FOOT* LOUNGE LEFT HAND LEFT HAND REVERSE* LINEAR LOCKER LOCKER ROOM* LIVE LOAD LINTEL LONGITUDINAL
DRW DS DSP DST DT DVTL DW DWG DWL DWR DX E ECR EF EIFS EL EL ELB	DITTO DINING ROOM DRAIN DRY WELL* DOWNSPOUT DRY STANDPIPE* DOOR STOP DRAIN TILE DOVETAIL DISHWASHER DRAWING DOWEL DRAWER DUPLEX EAST ELEVATOR CONTROL ROOM EACH FACE EXTERIOR INSULATION FINISH SYSTEM EASEMENT LINE* ELEVATION ELBOW	KOP LAU LAV LB LBR LD BRG LDG LDR LF LNGE LH LHR LIN LKR LKR RM LL LNTL LONG LP LPT	KNOCKOUT PANEL LAUNDRY LAVATORY POUND LABEL LUMBER LOAD BEARING* LANDING LEADER LINEAR FOOT* LOUNGE LEFT HAND LEFT HAND REVERSE* LINEAR LOCKER LOCKER LOCKER ROOM* LIVE LOAD LINTEL LONGITUDINAL LIGHT POLE* LOW POINT*
DRW DS DSP DST DT DVTL DW DWG DWL DWR DWR DX E ECR EF EIFS EL EL ELB ELB ELEC ELEV	DITTO DINING ROOM DRAIN DRY WELL* DOWNSPOUT DRY STANDPIPE* DOOR STOP DRAIN TILE DOVETAIL DISHWASHER DRAWING DOWEL DRAWER DUPLEX EAST ELEVATOR CONTROL ROOM EACH FACE EXTERIOR INSULATION FINISH SYSTEM EASEMENT LINE* ELEVATION ELBOW ELECTRICAL ELEVATOR	KOP LAU LAV LB LBR LD BRG LDG LDR LF LNGE LH LHR LIN LKR LKR RM LL LNTL LONG LP LPT LR LT	KNOCKOUT PANEL LAUNDRY LAVATORY POUND LABEL LUMBER LOAD BEARING* LANDING LEADER LINEAR FOOT* LOUNGE LEFT HAND LEFT HAND REVERSE* LINEAR LOCKER LOCKER LOCKER ROOM* LIVE LOAD LINTEL LONGITUDINAL LIGHT POLE* LOW POINT* LIVING ROOM* LIGHT
DRW DS DSP DST DT DVTL DW DWG DWL DWR DWR DX E ECR EF EIFS EL EL ELB ELEC ELEV EMP ENCL	DITTO DINING ROOM DRAIN DRY WELL* DOWNSPOUT DRY STANDPIPE* DOOR STOP DRAIN TILE DOVETAIL DISHWASHER DRAWING DOWEL DRAWER DUPLEX EAST ELEVATOR CONTROL ROOM EACH FACE EXTERIOR INSULATION FINISH SYSTEM EASEMENT LINE* ELEVATION ELBOW ELECTRICAL ELEVATOR EMPLOYEE ENCLOSURE	KOP LAU LAV LB LBR LD BRG LDG LDR LF LNGE LH LHR LIN LKR LKR RM LL LNTL LONG LP LPT LR LT LT LT WT LTG	KNOCKOUT PANEL LAUNDRY LAVATORY POUND LABEL LUMBER LOAD BEARING* LANDING LEADER LINEAR FOOT* LOUNGE LEFT HAND LEFT HAND REVERSE* LINEAR LOCKER LOCKER LOCKER ROOM* LIVE LOAD LINTEL LONGITUDINAL LIGHT POLE* LOW POINT* LIVING ROOM* LIGHT LIGHTWEIGHT LIGHTING
DRW DS DSP DST DT DVTL DW DWG DWL DWR DWR DX E E ECR EF EIFS EL EL ELB ELEC ELEV EMP	DITTO DINING ROOM DRAIN DRY WELL* DOWNSPOUT DRY STANDPIPE* DOOR STOP DRAIN TILE DOVETAIL DISHWASHER DRAWING DOWEL DRAWER DUPLEX EAST ELEVATOR CONTROL ROOM EACH FACE EXTERIOR INSULATION FINISH SYSTEM EASEMENT LINE* ELEVATION ELBOW ELECTRICAL ELEVATOR EMPLOYEE	KOP LAU LAV LB LBR LD BRG LDG LDR LF LNGE LH LHR LHR LKR LKR KR KR LKR LKR LKR LKR LT LT LT LT LT	KNOCKOUT PANEL LAUNDRY LAVATORY POUND LABEL LUMBER LOAD BEARING* LANDING LEADER LINEAR FOOT* LOUNGE LEFT HAND LEFT HAND REVERSE* LINEAR LOCKER LOCKER ROOM* LIVE LOAD LINTEL LONGITUDINAL LIGHT POLE* LOW POINT* LIVING ROOM* LIGHT LIGHTWEIGHT

T* *	M MAINT MAN MAS MATL MATV	METER* MAINTENANCE MANUAL* MASONRY* MATERIAL MASTER ANTENNA
X *	MAX MBR MC MECH MED MET METB METB MEZZ MFG MH MIN	TELEVISION SYSTEM* MAXIMUM MASTER BEDROOM* MEDICINE CABINET MECHANICAL MEDIUM* MEMBRANE METAL METAL BASE MEZZANINE MANUFACTURING MANHOLE MINIMUM
R E* W	MIR MISC ML MLDG MLWK MO MTD MTD MTG MULL MULT	MIRROR MISCELLANEOUS METAL LATH* MOLDING MILLWORK* MASONRY OPENING MOUNTED MOUNTING MULLION* MULLION* MULTIPLE NORTH
	NA NEG NIC NO NOM NTS O/O OA	NOT APPLICABLE NEGATIVE NOT IN CONTRACT NUMBER NOMINAL NOT TO SCALE OUT TO OUT* OVERALL
<u>-</u> *	OC OD OF OFCI OFOI OPNG OPP	ON CENTER OUTSIDE DIAMETER OUTSIDE DIMENSION* OUTSIDE FACE OWNER FURNISHED - CONTRACTOR OWNER FURNISHED - OWNER INSTALLED OPENING OPPOSITE
RING*	OPT ORIG OS OVHD OZ PACK PARG	OPTIONAL* ORIGINAL OVERFLOW SCUPPER OVERHEAD OUNCE PACKAGE PARKING
T IPE*	PBD PC PC PCD PED PERF PERIM PERP PI PKWY PL PLAM PLAS PLAT PLAS PLAT PLBG PLF PLYWD	PARTICLEBOARD* POINT OF CURVE PULL CHAIN* PAPER CUP DISPENSER PEDESTAL PERFORATED PERIMETER* PERMANENT PERPENDICULAR POINT OF INTERSECTION PARKWAY PLATE PROPERTY LINE PLASTIC LAMINATE* PLASTER PLATFORM* PLUMBING* POUNDS PER LINEAR FOOT* PLYWOOD
ESSIBLE E	PNL PNT POL POLY POS PR PRCST PREFAB PREFIN PREFIN PRELIM PROP PSCONC PSF PSI PT PTD PTN PVMT	PANEL PAINT POLISHED POLYETHYLENE* POSITIVE PAIR PRECAST PREFABRICATED PREFINISHED* PRELIMINARY PARKING* PROJECT PROPERTY PRESTRESSED CONCRETE* POUND PER SQUARE FOOT POUND PER SQUARE FOOT POUND PER SQUARE INCH PRESERVATIVE TREATED PAPER TOWEL DISPENSER* PARTITION PAVEMENT*
OR*	QT QTR	QUARRY TILE* QUARTER
AME ION, AIR R I CLASS	R RA RA GR RAD RBR RC RD RD	RISER RETURN AIR* RETURN AIR GRILLE* RADIUS RUBBER REINFORCED CONCRETE ROAD ROOF DRAIN
ION	REC RECPT RECT REF REINF REM REQD RES RESIL REST REST RET RFG RH	RECESSED RECEPTACLE RECTANGULAR REFERENCE REINFORCE (D) (ING) (MENT) REMOVABLE REQUIRED RESIDENT RESILIENT REST ROOM RETURN* ROOFING RIGHT HAND
	RHR RLF RLG RM RND RO ROW RV RVS RVS RWL	RIGHT HAND REVERSE* RELIEF RAILING ROOM ROUND ROUGH OPENING RIGHT OF WAY* ROOF VENT* REVERSE RAIN WATER LEADER* SOUTH
E*	SA SB SCHED SCMU SD SD SDL SECT SEG SERV SGL SHR SHT	SUPPLY AIR* SPLASH BLOCK SCHEDULE SOLID CONCRETE MASONRY UNIT* SOAP DISPENSER STORM DRAIN* SADDLE SECTION SEGMENT SERVICE SINGLE SHOWER* SHEET (ING)*
CRETE	SHTGH SHV SIM SJ SK	SHEATHING SHELVES (ING) SIMILAR SCORED JOINT* SINK

SLP SLV SM SM
SMLS SND SNR
SPEC SPKLR SPLY SQ FT SQ IN SSK SST STA STA STC STD STIF STIR STK STL STL JST STL PL STOR STRUCT SUSP SUSP CLG SW SYM SYMM
T T&B T&G TB TB
TC TC TD TD TE TECH TEL TEMP TEMP
TEN TF TFA TFB TFF THK THRES THRU TJ
TEMPD GL TOS TOT TOW TP TPH TST TV
TYP UGND UNFIN UNO UR VB\ VCT
VERT VEST VIF VIN VOL VR VT VWC
W W/O W/W WC WDSP WDW WF WGL WH WHTR WI WL WLD WR
WS WSCT WTRPRF WWF* X SECT XFMR

SLOPE

SLEEVE

SHEET METAL* SMOOTH*

SANITARY NAPKIN

SEAMLESS

DISPENSER SANITARY NAPKIN

RECEPTACLE

SPRINKLER*

SQUARE FOOT SQUARE INCH

SERVICE SINK STAINLESS STEEL STATION

STAGGERED*

STANDARD STIFFENER

STIRRUP

STEEL JOIST*

STEEL PLATE*

STRUCTURAL*

SUSPENDED

SIDEWALK*

SYMMETRICAL

TOP OF BEAM*

TOP OF CURB*

TOWEL BAR*

TOP AND BOTTOM

TOP OF CONCRETE*

TOWEL DISPENSER* TRENCH DRAIN*

TOP ELEVATION*

TO FLOOR BELOW TO OF FINISH FLOOR*

TEMPERED GLASS*

TOP OF PAVEMENT* TOILET PAPER HOLDER*

TOP OF SLAB TOTAL TOP OF WALL

TOP OF STEEL*

UNDERGROUND

UNLESS NOTED OTHERWISE*

TELEVISION

UNFINISHED

TYPICAL

URINAL VINYL BASE* VINYL COMPOSITION

TII F*

VERTICAL VESTIBULE

VINYL*

VOLUME

VINYL TILE*

West With Without

WOOD

WALL TO WALL* WATER CLOSET

WASTE DISPOSER* WINDOW*

WIDE FLANGE*

WROUGHT IRON WIND LOAD

WATER RESISTANT* WEATHERSTRIPPING

CROSS SECTION TRANSFORMER

WIRE GLASS WALL HUNG* WATER HEATER

WELDED

WAINSCOT* WATERPROOFING* WELDED WIRE FABRIC*

VERIFY IN FIELD

VAPOR RETARDER

VINYL WALL COVERING*

THICKNESS* THRESHOLD*

THROUGH TOP OF JOIST*

TECHNICAL

TELEPHONE **TEMPERATURE** TEMPORARY TENANT TOP OF FOOTING* **TO FLOOR ABOVE***

TONGUE AND GROOVE

SYMBOL

TREAD*

SUSPENDED CEILING*

STORAGE

STAKE*

STEEL


SOUND TRANSMISSION CLASS*

SUPPLY


SPECIFICATION

NOTE: AN ASTERISK (*) INDICATES THE TERM IS NOT IN ANSI Y1.1 OR THAT THE ABBREVIATION SHOWN IS NOT IN COMPLIANCE WITH THE ONE SHOWN IN ANSI Y1.1. THE ABSENCE OF AN ASTERISK INDICATES THE ABBREVIATION AGREES WITH ANSI Y1.1




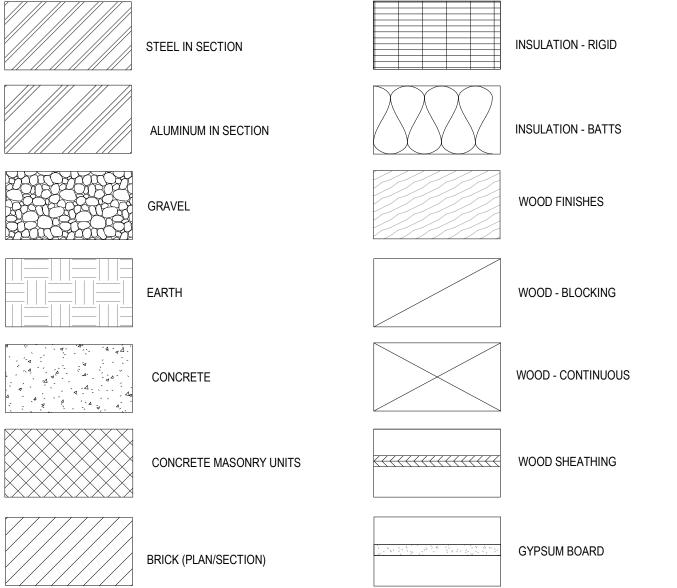

GRAPHIC SYMBOLS

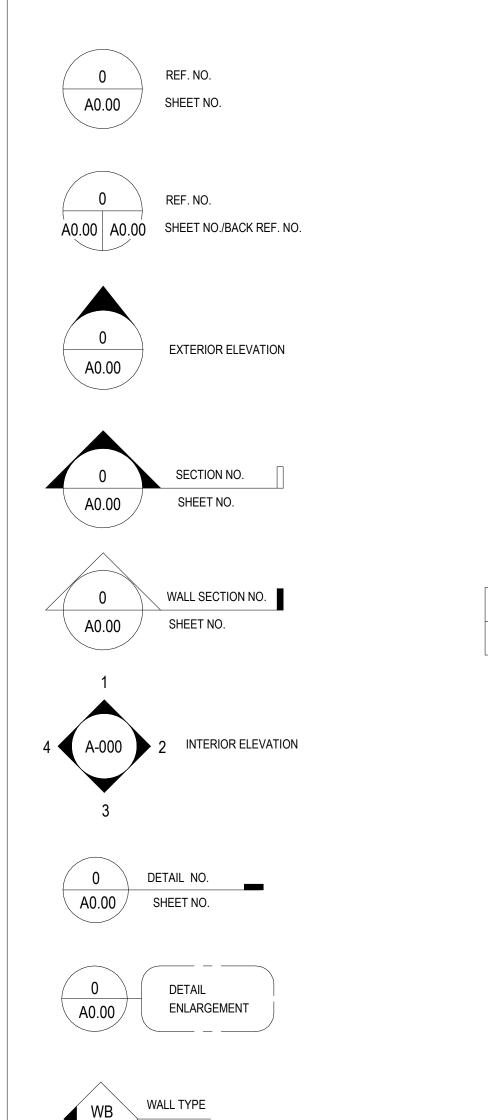

00

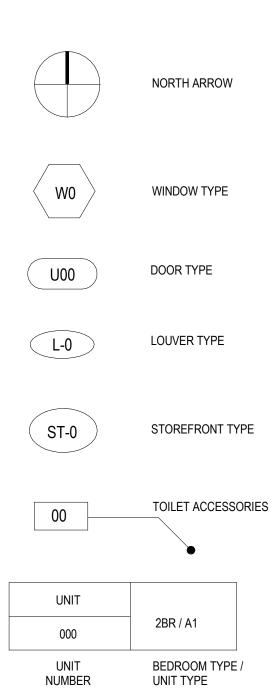

PARKING NO. DESIGNATION



HANDICAPPED



SLAB ELEVATION


X' - X" CEILING HEIGHT

GENERAL NOTES:

- AREAS AND STORAGE REQUIREMENTS. 3.
- 6
- 8.

- 14.

VICINITY PLAN

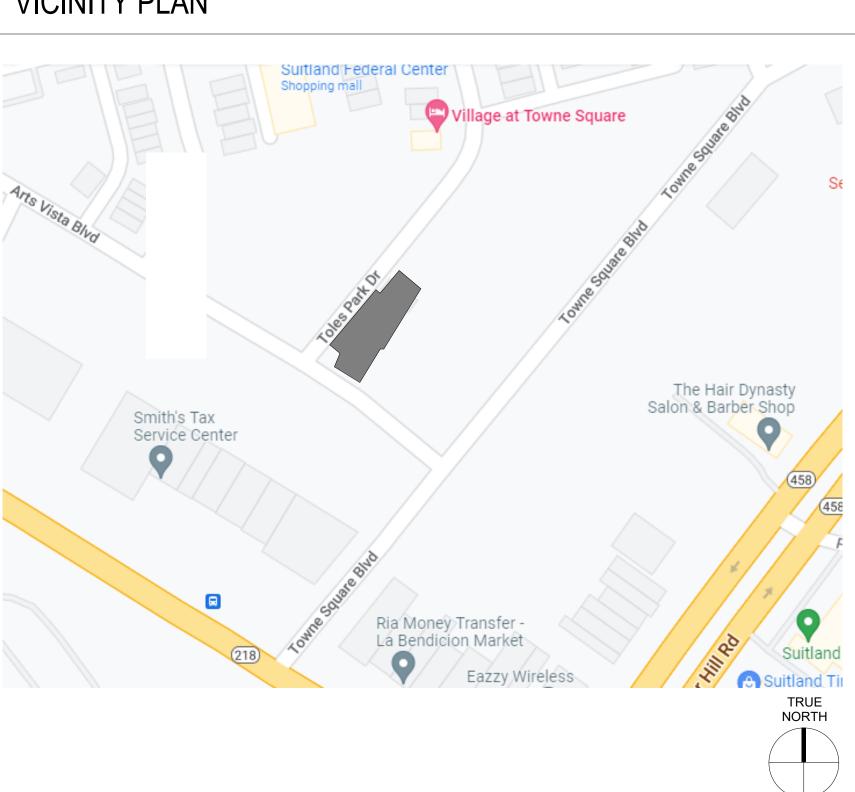

1. CONTRACTOR SHOULD VISIT AND BECOME FAMILIAR WITH THE SITE PRIOR TO BIDDING.

2. COORDINATE AND SECURE OWNER'S AGREEMENT FOR ACCESS TO SITE CONSTRUCTIONS, STAGING

PROVIDE ALL WORK IN STRICT ACCORDANCE WITH ALL APPLICABLE CODES, ORDINANCES, REGULATIONS AND ANY ADDITIONAL REQUIREMENTS SO STATED BY ANY LAW, ORDINANCE OR REGULATION PERTAINING TO CONSTRUCTION WITHIN THE SAID LIMITS OF THE JURISDICTION.

4. ACCOMPLISH ALL CONSTRUCTION IN COMPLIANCE WITH THE OCCUPATIONAL, SAFETY AND HEALTH ACT AND OTHER APPLICABLE RULES AND REGULATIONS. THE CONTRACTOR SHALL ASSUME FULL RESPONSIBILITY AND LIABILITY FOR COMPLIANCE WITH ALL APPLICABLE REGULATIONS PERTAINING TO THE HEALTH AND SAFETY OF PERSONNEL DURING THE EXECUTION OF WORK, AND SHALL HOLD THE OWNER AND ARCHITECT HARMLESS OF ANY ACTION ON HIS/HER PART OR THAT OF HIS/HER EMPLOYEES OR SUBCONTRACTORS, WHICH RESULTS IN ILLNESS, INJURY OR DEATH. IT SHALL BE THE CONTRACTOR'S RESPONSIBILITY TO COMPLY WITH ALL SUCH LAWS AND REGULATIONS.

5. COORDINATE CONSTRUCTION ACTIVITIES TO ASSURE EFFICIENT AND ORDERLY INSTALLATION OF EACH PART OF WORK MAINTAIN SURFACE STREET AND SURFACE PARKING AREAS IN A CLEAN CONDITION. MUD, DEBRIS AND DUST FREE AT ALL TIMES AND PROVIDE ADEQUATE MEANS TO CLEAN TRUCKS AND OTHER EQUIPMENT USING SURFACED STREETS AND PARKING AREAS.

7. INFORM OWNER AND ARCHITECT OF CONDITIONS WHICH MAY AFFECT THE CONSTRUCTION AS SHOWN. BRING TO THE ATTENTION OF THE OWNER ANY MATERIAL SUSPECTED OF BEING HAZARDOUS ENCOUNTERED DURING EXECUTION OF THE WORK. A DETERMINATION WILL BE MADE BY THE OWNER AS TO WHETHER THE CONTRACTOR SHALL PERFORM TEST TO DETERMINE IF THE MATERIAL IS HAZARDOUS.

9. PROTECT EXISTING ADJACENT AREAS FROM DAMAGE DURING EXECUTION OF THE WORK. REPLACE ALL ITEMS DAMAGED DURING THE WORK AT THE CONTRACTOR'S EXPENSE.

10. REFER TO PLUMBING DRAWINGS FOR LOCATION OF OPENINGS FOR PLUMBING FIXTURES.


11. REFER TO M.E.P. DRAWINGS FOR LOCATION AND COORDINATION OF BATHROOMS, VENTS AND FLUES.

12. UPON COMPLETION OF WORK, REMOVE TOOLS, EQUIPMENT, TEMPORARY PROTECTION AND EXCESS MATERIALS FROM SITE. REMOVE ALL PAINT DRIPS/ SPLATTERS, CLEAN/ POLISH ALL HARDWARE AND FIXTURES. REMOVE PROTECTION AND LEAVE INTERIOR AREAS BROOM CLEAN AND FREE OF STAINS, FILM AND SIMILAR FOREIGN SUBSTANCES.

13. PROVIDE CONTINUOUS SEALANT AT ALL JOINTS BETWEEN DISSIMILAR MATERIALS OR CONSTRUCTION.

SHOULD DISCREPANCIES BE DISCOVERED BETWEEN DETAILS AND/OR PLANS. IT WILL BE THE CONTRACTORS RESPONSIBILITY TO ASK THE QUESTION THAT RESOLVES THE DISCREPANCY BEFORE PROCEEDING WITH ANY WORK, OTHERWISE THE CONTRACTOR WILL BE RESPONSIBLE FOR CORRECTING THE DISCREPANCY AT THEIR OWN COST. THE QUESTION SHALL BE IN FORM OF AN RFI WITH SUGGESTION INCLUDED.



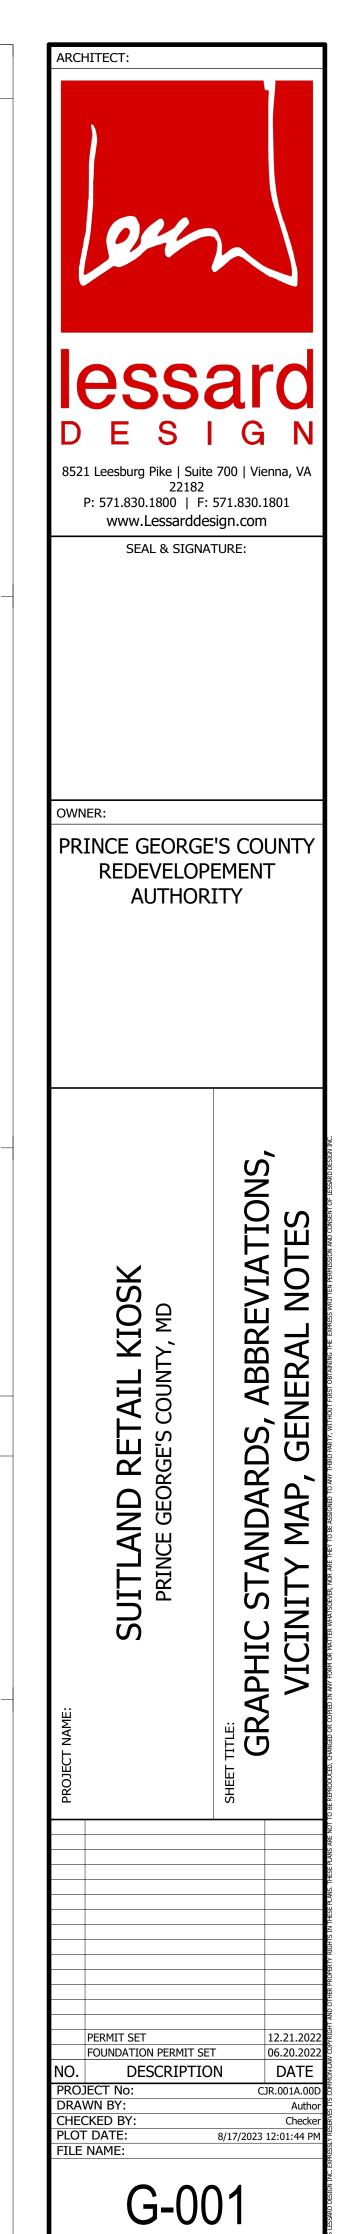

Prince George's C CODE ANALYSIS	Journy							
Updated: 12.21.2022 Issue			Allowed	d or Required	ł			Proposed
Project Description			7	a of frequiner	-			
New construction of one s shop tenants.	story,free standing ret	ail kiosk located	in the mic	dle of Suitla	nd town square,	Maryland for a new Multi-Far	nily devel	opment. Scope of work
APPLICABLE CODES Building	5		2018 N	PA 101 Life	Safaty Codo:			
Building					orge's County Fire	e Safety Code;		
				ternational Bu	ilding Code; rge's County Build	ling Codo:		
Structural				ternational Bu		ling Code,		
Mechanical					rge's County Build echanical Code (IN	°		
Plumbing					umbing Code (IPC	/		
Electrical					nal Electrical Code	,		
Energy					rge's County Elect lergy Conservation			
International Fuel & Gas	Code		2018 Int	ernational Fu	el Gas Code (IFG	C)		
Sprinkler Accessibility					ation of Sprinkler S	Systems . 4-180 Chapter 11 - Accessibil	lity.	
Accessionity			COMAR	R 9.12.53 Mar	yland Accessibility		ity,	
			2010 AE	DA Standards				
FUNDAMENTALS USE GROUP(S)			Assemb	ly Group A-2:	Restaurants, Cat	feterias and similar dining facili	tes.	Group A-2
~ /					, • •			
CONSTRUCTION TYPE AUTOMATIC FIRE SPRI			Require	d in Group A	2 with an occupan	t load more than 100.		Type II-B (protected) Building will be fully spri
STANDPIPES			Not requ	uired in Occup	pancy A having a c	occupant load not exceeding 1,		Not required
			persons	and less that	n 30' height above	the fire department vehicle ac	cess.	
PORTABLE FIRE EXTIN	GUISHERS		Require	d for Group A	and B			Refer to plan for location
MANUAL FIRE ALARM			not requ	ired per exce	ption - where the t	ouilding is equipped throughout		N/A
			occupar	nt notification	appliance will activ	ce with section 903.3.1.1 and the vate throughout the notification		
Total Allowable Height (F	eet / Stories)			rinkler water 3 Stories	now			15'-6" / 1-story
Max. Area per floor (gsf)			38,000 s	sf				4,014 sf
RATINGS FOR BUILD								
RATINGS FOR BUILDING		FIRE SEPAR		JISTANCE				
Structural Frame / columr	าร		0-hour					0-hour
Exterior Bearing Walls			0-hour					0-hour
Interior Bearing Walls Nonbearing Interior walls			0-hour 0-hour					0-hour 0-hour
Floor Construction, includ			0-hour					0-hour
Roof Construction, includ	•		0-hour					0-hour
Fire Separation Distance	- Exterior Walls		0-hour v	vhen fire sepa	aration is 30' or mo	ore		0-hour
EGRESS OCCUPANT LOADS			1					
TOTAL OCCUPANCY			204 OC	С				
EXIT ARRANGEMENT Number of Exits						n 49 occupant load per story a	nd more	
Common Path of Travel (Occupancy A F M)			common pat	e	distance, 2 Exits are required		
Common Path of Travel (pants)		m 100 feet O				
Remoteness					-	I (Sprinklered Building)		
Travel Distance - Occupa	ncy A				klered Building)	gh areas on level of discharge	ainaa	
Exit Discharge					eparated, and sprir	0	, since	
ACCESSIBILITY			-		· · ·			
Common Area Accessibil	ity		Accessi	ble routes and	d facilities required			
SUITLAND TOWN CEN		1						
Classification (Table 1004.5)	Occupancy Use (Table 2902.1)	Descrip	otion	Actual Area	Number of Occupants	Ratio	Wate Male	r Closets Ratio
(1004.3)				Alea	occupants			en and 50% Women
Business	В	Office		116	1	1 per 25 for the first 50		1 per 25 for the first 50
ITED Cross (Oss)						and 1 per 50 for the remainder exceeding 50	0.04	per 50 for the remain exceeding 50
(150 Gross/Occ)								1
		Mechanical,		162	1	1 per 100	0.01	1 per 100
Accessory	S		า			1	-	1
``````````````````````````````````````	S	Closet, Trash			3	1 per 100	0.02	1 per 100
Accessory	S	Closet, Trasł		245				
Accessory (300 Gross/Occ) Accessory	S	Closet, Trash		245			-	· .
Accessory (300 Gross/Occ) Accessory (100 Gross/Occ)			1			2 1 per 75	1.33	2
Accessory (300 Gross/Occ) Accessory (100 Gross/Occ)	S Assembly (Restaurants)	Closet, Trash	]	245	199	1 per 75	1.33	2 1 per 75
Accessory (300 Gross/Occ) Accessory (100 Gross/Occ) Asembly (A-2) (15 Net/Occ)	Assembly		]			-		2
Accessory (300 Gross/Occ) Accessory (100 Gross/Occ) Asembly (A-2)	Assembly		]			1 per 75	1.33 1.38 1.38 2	2 1 per 75


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			Code Refere	ence				Re	marks			
ork will be t	to provide	structure and stub in ut	tilities and th	e Kiosk is	to be inte	erior fit	-out r	eady by	future coffee			
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											<b>ess</b>	ard
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sprinkled			IBC 903.2.1. IFC 905.3.2	2:Subtitle 4	4 Sec. 4-1	58						
ation			IFC 906.1									
			IBC 907.2.1									
			IBC Table 50	)4.3 and 5(	04.4							
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			IBC Table 10	06.3.2								
			IBC Table 10 IBC Table 10									
			IBC 1007.1.1 IBC Table 10									
			IBC 1028.1(1	1)								
			ADAAG, DC	MR 12A, A	NSI A117						$\mathbf{X}$	
			avatories				rinki	na			O O Q	
	Female	Ratio Assume 50%		Male % Womer	Female			DF	Service Sink			SIS
50 and 1 nainder	0.04	1 per 40 for the first 80 80 for the reminder ex	) and 1 per	0.03	0.03	1 per	100	0.01			SUITLAND RETAIL KIOSK PRINCE GEORGE'S COUNTY, MD	CODE ANALYSIS
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	0.02	1 1 per 200		0.01	0.01	1 per	500		Note 1		D - EOR	
	0.02	2 T per 200			0.01	1 per	500	0.01			ITLAND RET PRINCE GEORGE'S	
	1.33	1 per 200		0.50	0.50	1 per	500	0.40			TL	Ŭ
	1.38	100		0.53	0.53			0.41			IU:	
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G-011



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16'-0"

### COMcheck Software Version 4.1.5.5 Envelope Compliance Certificate

Project Information Energy Code: Project Title: Location: Climate Zone: Project Type:

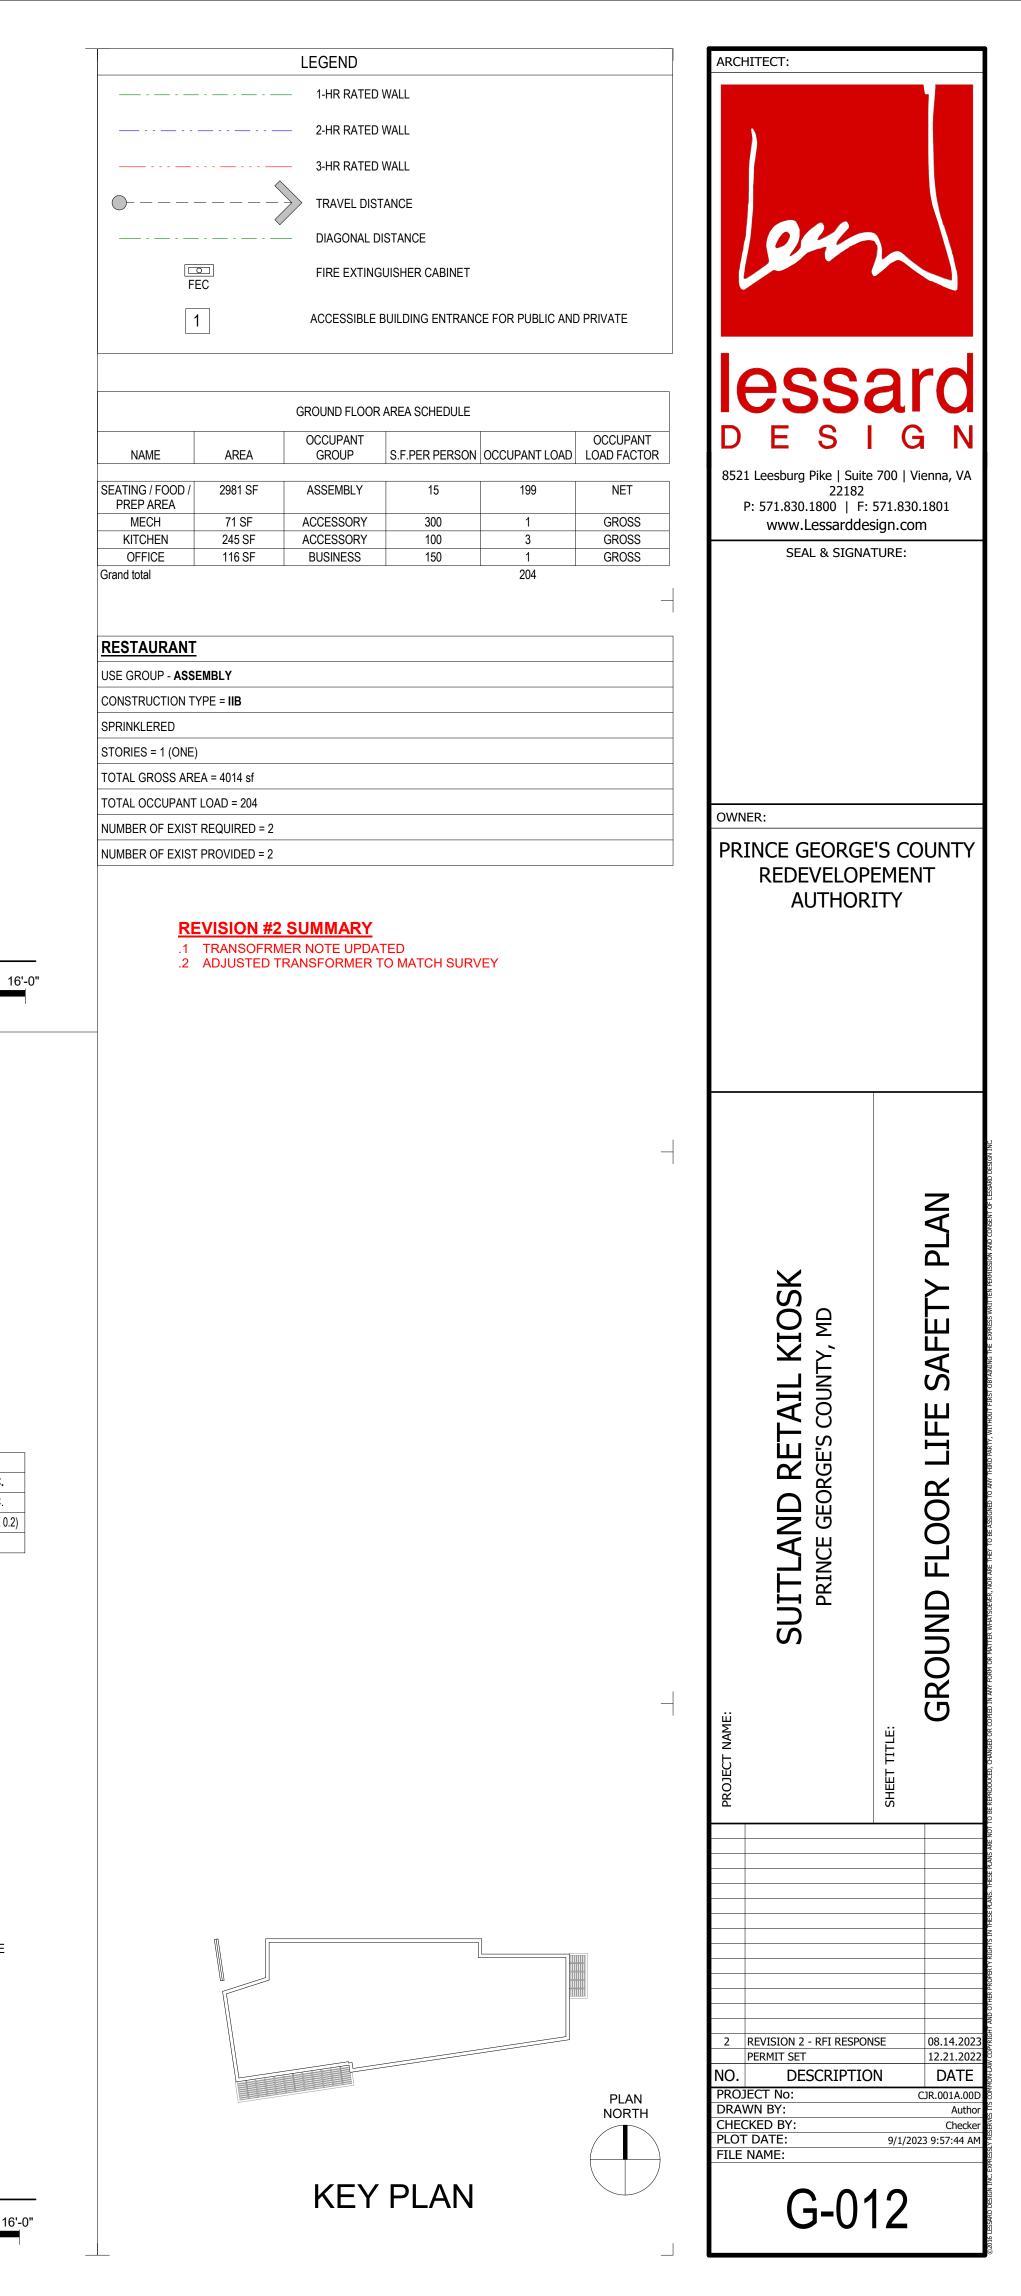Vertical Glazing / Wall Area:

2018 IECC SUITLAND RETAIL KIOSK Baltimore, Maryland 4a New Construction

Construction Site: PRINCE GEORGE'S COUNTY Owner/Agent: COBER JONHSON & ROMNEY 7500 GREENWAY CENTER DRIVE, SUITE 910 GREENBELT, MD 20770 301.426.3737

E-mail :nromney@cjrlegal.com

Designer/Contractor: LESSARD DESIGN, INC. 8251 Leesburg Pike, Suite 700 Vienna, MD 22182 571.830.1800 E-mail :cboone@lessarddesign.com

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Additional Efficiency Package(s) Credits: 1.0 Required 1.0 Proposed

On-site Renewable Energy, 1.0 credit

 Building Area
 Floor Area

 1-Restaurants, cafeterias and similar dining facility (Retail) :
 4147

 Nonresidential
 4147

23%

Envelope Assemblies

Assembly	Gross Area or Perimeter	Cavity R-Value	Cont. R-Value	Proposed U-Factor	Budget U- Factor _{ix}
NORTH WALL TYPE SB87: Steel-Framed, 16" o.c., [Bldg. Use 1 - Restaurants, cafeterias and similar dining facility]	493	21.0	7.5	0.059	0.064
W-SE3: Metal Frame:Fixed, Perf. Specs.: Product ID APO, SHGC 0.32, [Bidg. Use 1 - Restaurants, cafeterias and similar dining facility] (b)	80			0.380	0.380
D-100A: Glass (> 50% glazing):Metal Frame, Entrance Door, Perf. Specs.: Product ID APO, SHGC 0.24, [Bidg. Use 1 - Restaurants, cafeterias and similar dining facility] (b)	47			0.320	0.770
EAST WALL TYPE SB87: Steel-Framed, 16" o.c., [Bidg. Use 1 - Restaurants, cafeterias and similar dining facility]	1644	21.0	7.5	0.059	0.064
W-SE4: Metal Frame:Fixed, Perf. Specs.: Product ID APO, SHGC 0.32, [Bidg. Use 1 - Restaurants, cafeterias and similar dining facility] (b)	41			0.380	0.380
W-SE1: Metal Frame:Fixed, Perf. Specs.: Product ID APO, SHGC 0.32, [Bidg. Use 1 - Restaurants, cafeterias and similar dining facility] (b)	120			0.380	0.380
W-SE1: Metal Frame:Fixed, Perf. Specs.: Product ID APO, SHGC 0.32, [Bidg. Use 1 - Restaurants, cafeterias and similar dining facility] (b)	120			0.380	0.380
W-SE2: Metal Frame:Fixed, Perf. Specs.: Product ID APO, SHGC 0.32, [Bidg. Use 1 - Restaurants, cafeterias and similar dining facility] (b)	160			0.380	0.380
D-00D: Glass (> 50% glazing):Metal Frame, Entrance Door, Perf. Specs.: Product ID APO, SHGC 0.32, [Bldg. Use 1 - Restaurants, cafeterias and similar dining facility] (b)	24			0.450	0.770

Project Title: SUITLAND RETAIL KIOSK Report date: 12/22/22
Data filename: N:\Harold Johnson\CJR.001A.00D - Suitland Kiosk\01 Project\COMCHECK\KIOSK-COMCHECK.cck Page 1 of 10

Assembly	Gross Area or Perimeter	Cavity R-Value	Cont. R-Value	Proposed U-Factor	Budget U- Factor ₁₀
D-100C: Insulated Metal, Garage door 14% glazing, [Bldg, Use 1 - Restaurants, cafeterias and similar dining facility]	80			0.770	0.310
D-100B: Insulated Metal, Garage door 14% glazing, [Bldg. Use 1 - Restaurants, cafeterias and similar dining facility]	80			0.770	0.310
OUTH					
WALL TYPE SB87: Steel-Framed, 16" o.c., [Bidg. Use 1 - Restaurants, cafeterias and similar dining facility]	672	21.0	7.5	0.059	0.064
W-SE6: Metal Frame:Fixed, Perf. Specs.: Product ID APO, SHGC 0.32, Bidg. Use 1 - Restaurants, cafeterias and similar dining facility] (b)	170			0.380	0.380
D-100E: Glass (> 50% glazing):Metal Frame, Entrance Door, Perf. Specs.: Product ID APO, SHGC 0.24, [Bldg. Use 1 - Restaurants, afeterias and similar dining facility] (b)	48			0.320	0.770
/EST					
VALL TYPE SE1: Steel-Framed, 16" o.c., [Bidg. Use 1 - Restaurants, afeterias and similar dining facility]	1707	21.0	7.5	0.059	0.064
V-SE3: Metal Frame:Fixed, Perf. Specs.: Product ID APO, SHGC 0.32, Bidg. Use 1 - Restaurants, cafeterias and similar dining facility] (b)	80			0.380	0.380
V-SE1: Metal Frame:Fixed, Perf. Specs.: Product ID APO, SHGC 0.32, Bldg. Use 1 - Restaurants, caleterias and similar dining facility] (b)	120			0.380	0.380
D-105: Glass (> 50% glazing):Metal Frame, Entrance Door, Perl. Specs.: Product ID APO, SHGC 0.35, [Bldg. Use 1 - Restaurants, cafeterias and similar dining facility] (b)	42			0.380	0.770

(a) Budget U-factors are used for software baseline calculations ONLY, and are not code requirements.
 (b) Fenestration product performance must be certified in accordance with NFRC and requires supporting documentation.

Envelope PASSES: Design 1% better than code


Envelope Compliance Statement


Compliance Statement: The proposed envelope design represented in this document is consistent with the building plans, specifications, and other calculations submitted with this permit application. The proposed envelope systems have been designed to meet the 2018 IECC requirements in COMcheck Version 4.1.5.5 and to comply with any applicable mandatory requirements listed in the Inspection Checklist.

Name - Title

Signature

Date

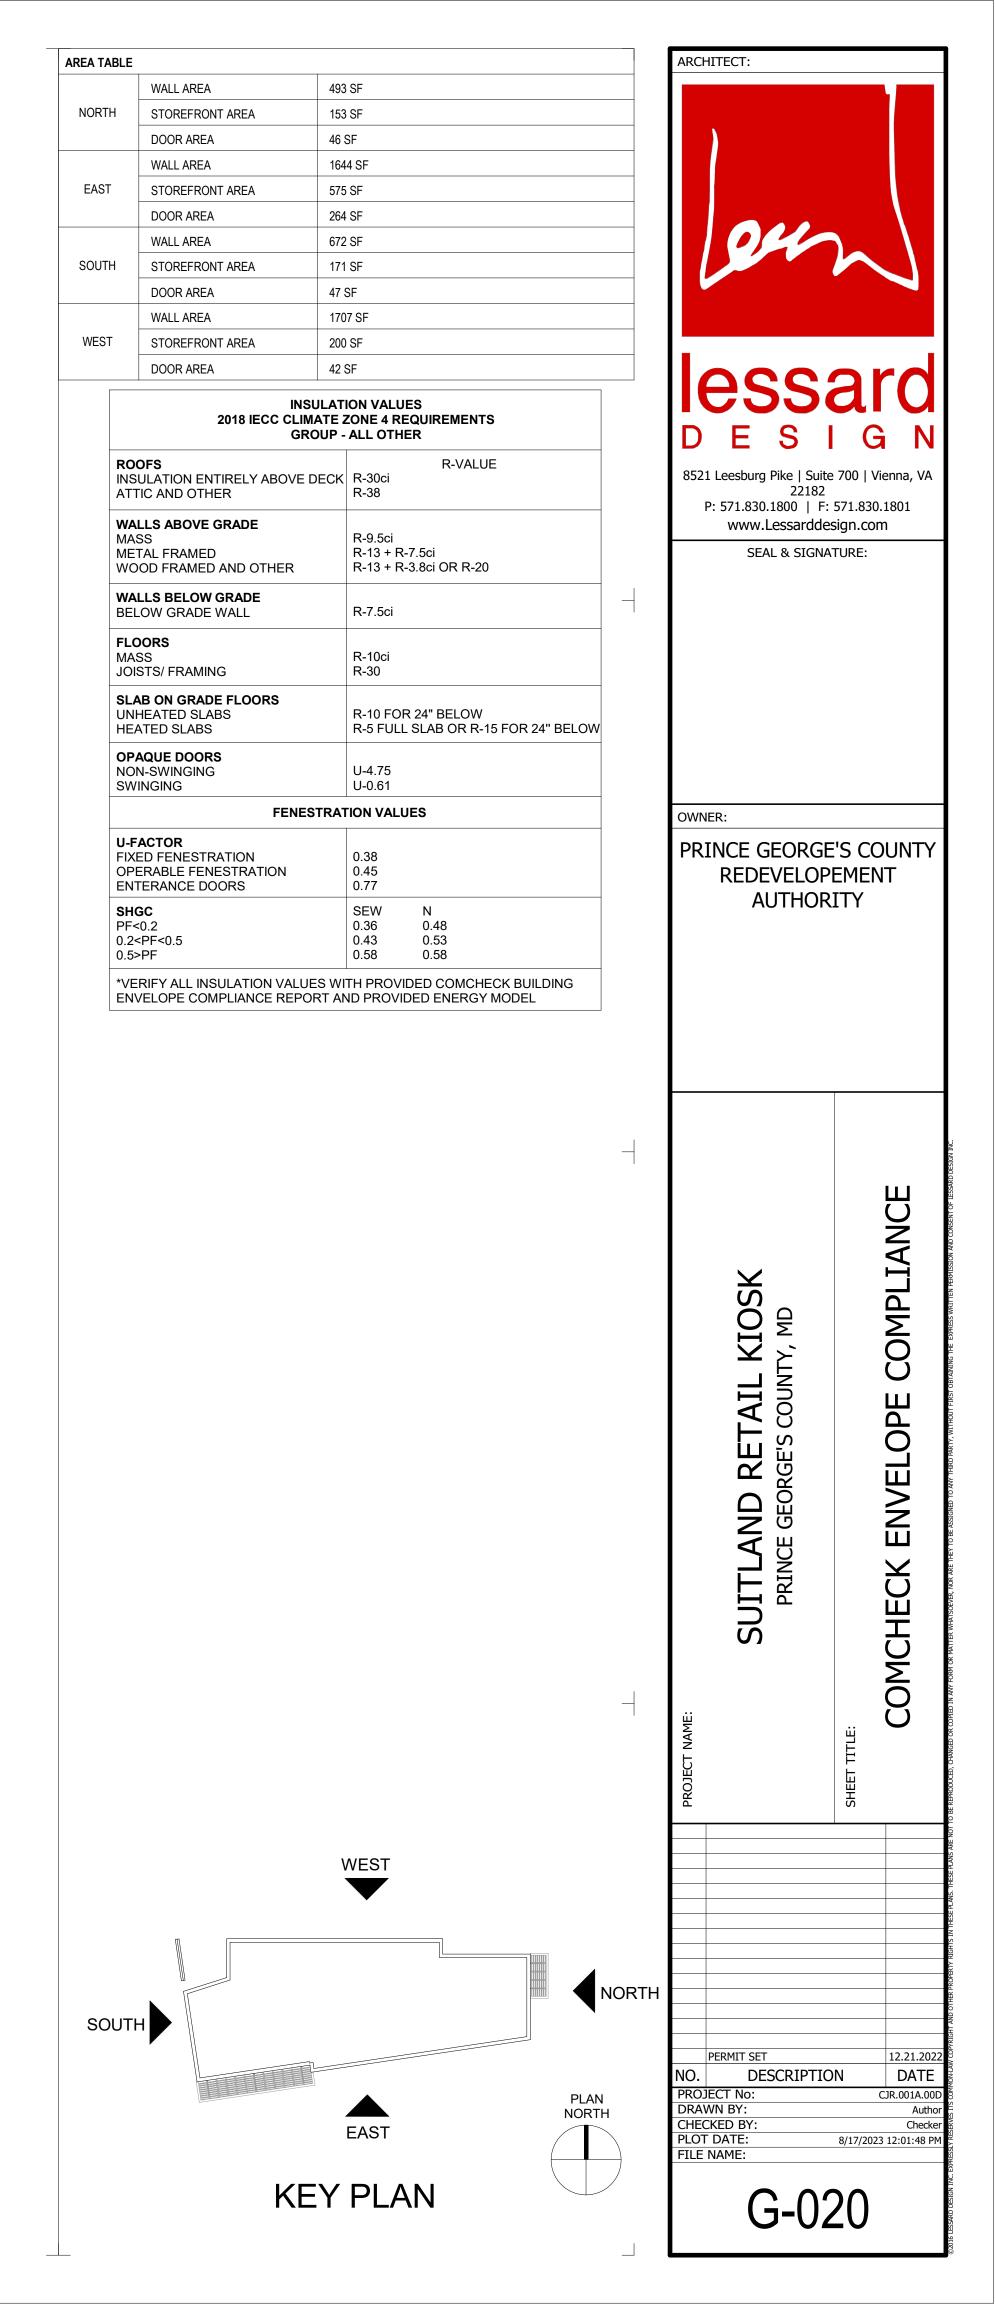

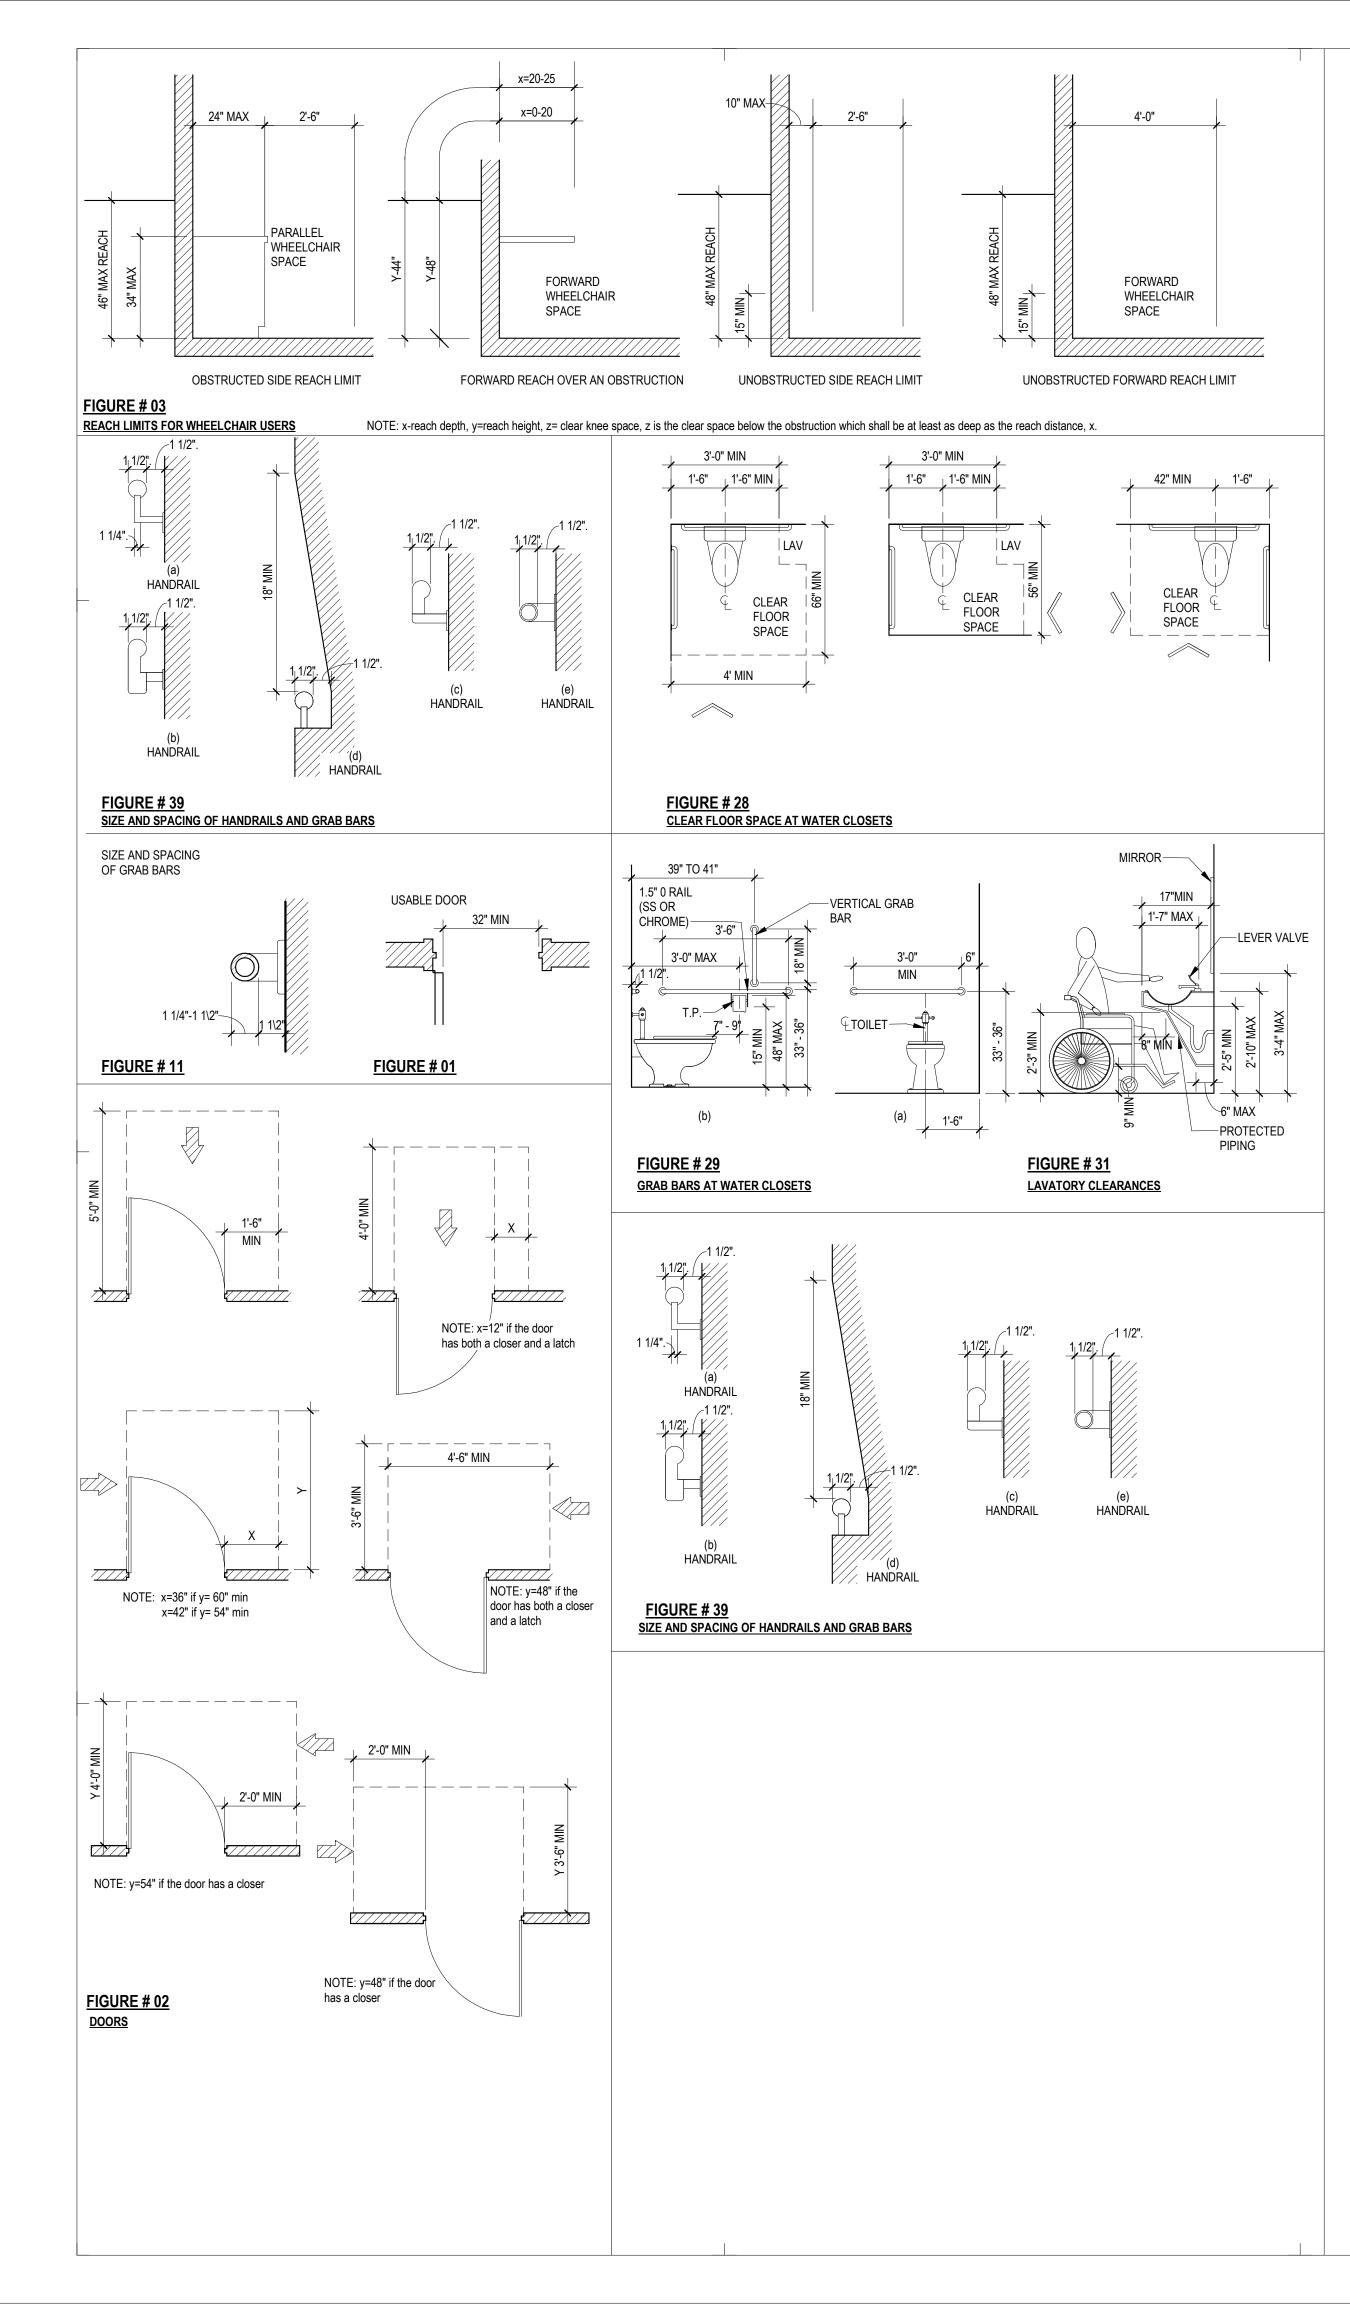

<u>2010 ADA STAND</u>	DARD
<b>101.1 GENERAL:</b> THIS DOCUMENT CONTAINS SCOPING AND TECHNICAL INDIVIDUALS WITH DISABILITIES. THE REQUIREMENTS ARE TO BE A	APPLIED DU
SITES, FACILITIES, BUILDINGS, AND ELEMENTS TO THE EXTENT REC DISABILITIES ACT OF 1990. 206 ACCESSIBLE ROUTES	
206.1 GENERAL: ACCESSIBLE ROUTES SHALL BE PROVIDED IN ACCORD. 206.2 WHERE REQUIRED: ACCESSIBLE ROUTES SHALL BE PROVIDED WH 206.2.1 SITE ARRIVAL POINTS : AT LEAST ONE ACCESSIBLE ROUTE SHA	WHERE RE
PASSENGER LOADING ZONES; PUBLIC STREETS AND SIDEWALKS; A THEY SERVE.	; AND PUBL
206.2.2 WITHIN A SITE: AT LEAST ONE ACCESSIBLE ROUTE SHALL CONN ACCESSIBLE SPACES THAT ARE ON THE SAME SITE.	
<ul> <li>206.3 LOCATION: ACCESSIBLE ROUTES SHALL COINCIDE WITH OR BE LO PATHS ARE INTERIOR, REQUIRED ACCESSIBLE ROUTES SHALL ALSO</li> <li>206.4 ENTRANCES: ENTRANCES SHALL BE PROVIDED IN ACCORDANCE</li> </ul>	SO BE INTE
SHALL BE ON AN ACCESSIBLE ROUTE COMPLY WITH 402 6.4.1 PUBLIC ENTRANCES: IN ADDITION TO ENTRANCES REQUIRED BY COMPLY WITH 404.	BY 206.4.2 T
SECTION 206 FOR MORE INFORMATION. DOORS, DOORWAYS, AND GATES (ACCESSIBLE ROUTE) 1 GENERAL: DOORS, DOORWAYS, AND GATES THAT ARE A PART OF	
4.2 MANUAL DOORS, DOORWAYS, AND MANUAL GATE: MANUAL DOOL COMPLY WITH 404.2	ors and do
404.2.2 DOUBLE-LEAF DOORS AND GATE: AT LEAST ONE OF THE ACTIV 404.2.3 CLEAR WIDTH: DOOR OPENINGS SHALL PROVIDE A CLEAR WIDT SHALL BE MEASURED BETWEEN THE FACE OF THE DOOR AND THE S	DTH OF 32 IN
PROVIDE A CLEAR OPENING OF 36 INCHES MINIMUM. THERE SHALL INCHES ABOVE FINISH FLOOR OR GROUND. PROJECTIONS INTO TH	LL BE NO PR
OR GROUND SHALL NOT EXCEED 4 INCHES. 14.2.4 MANEUVERING CLEARANCES: MINIMUM MANEUVERING CLEARA SHALL EXTEND THE FULL WIDTH OF THE DOORWAY AND THE REQUI	
04.2.4.1 SWINGING DOORS AND GATE: SWINGING DOORS AND GATES \$ 04.2.4.2 DOORWAYS WITHOUT DOORS OR GATES, SLIDING DOORS, AN	S SHALL HAV
GATES, SLIDING DOOR, OR FOLDING DOORS SHALL HAVE MANEUVE 4.2.4.4 FLOOR OR GROUND SURFACE: FLOOR OR GROUND SURFACE V LEVEL ARE NOT PERMITTED.	E WITHIN REC
<ul> <li>404.2.5 THRESHOLDS: THRESHOLDS, IF PROVIDED AT DOORWAYS, SHAL DOORWAYS SHALL COMPLY WITH 302 AND 303.</li> <li>404.2.6 DOORS IN SERIES AND GATES IN SERIE: THE DISTANCE BETWEE</li> </ul>	EEN TWO HI
INCHES MINIMUM PLUS THE WIDTH OF DOORS OR GATES SWINGING 404.2.7 DOOR AND GATE HARDWAR: HANDLES, PULLS, LATCHES, LOCK OPERABLE PARTS OF SUCH HARDWARE SHALL BE 34 INCHES MINIM	CKS, AND OT IIMUM AND 4
DORS ARE IN THE FULLY OPEN OPPOSITION, OPERATING HARDWA 8 CLOSING SPEEL: DOOR AND GATE CLOSING SPEED SHALL COMF 8.1 DOOR CLOSERS AND GATE CLOSER: DOOR CLOSERS AND GATE 1.1 THE RECURRENT TO MOVE THE RECEIPTION OF 10 DEC	MPLY WITH 4 GATE CLOSEF
TIME REQUIRED TO MOVE THE DOOR TO A POSITION OF 12 DEC DOOR AND GATE SURFACE: SWINGING DOOR AND GATE SURF LL HAVE A SMOOTH SURFACE ON THE PUSH SIDE EXTENDING T ITS IN THESE SURFACES SHALL BE WITHIN 1/16" OF THE SAME P	RFACES WIT
YIN THESE SURFACES SHALL BE WITHIN 1/10 OF THE SAME P VISION LIGHT: DOORS, GATES, AND SIDE LIGHTS ADJACENT TO NG THROUGH THE PANELS SHALL HAVE THE BOTTOM OF AT L ET AND BATHING ROOMS	TO DOORS C
GENERAL: TOILET AND BATHING ROOMS SHALL COMPLY WITH 603 CLEARANCES : CLEARANCES SHALL COMPLY WITH603. 2 2.1 TURNING SPACE: TURNING SPACE COMPLYING WITH 304 SHALL	
2 OVERLAP: REQUIRED CLEAR FLOOR SPACES, CLEARANCES AT F 3 DOOR SWING: DOORS SHALL NOT SWING INTO THE CLEAR FLOO VING INTO THE REQUIRED TURNING SPACE.	OOR SPACE
RRORS: MIRRORS LOCATED ABOVE LAVATORIES OR COUNTERT ES MAXIMUM ABOVE THE FINISHED FLOOR OR GROUND. MIRR BOTTOM EDGE OF THE REFLECTING SURFACE 35 INCHES MAXI	RRORS NOT L
DAT HOOKS AND SHELVES: COAT HOOKS SHALL BE LOCATED WI IES MINIMUM AND 48 INCHES MAXIMUM ABOVE THE FINISH FLOO FER CLOSETS AND TOILET COMPARTMENTS	OOR OR GR
GENERAL : WATER CLOSETS AND TOILET COMPARTMENTS SHALL LOCATION: THE WATER CLOSET SHALL BE POSITIONED WITH A W OSET SHALL BE 16 INCHES MINIMUM TO 18 INCHES MAXIMUM FRO	WALL OR PA
CHES MINIMUM AND 19 INCHES MAXIMUM FROM THE SIDE WALL O 4.8.2. WATER CLOSETS SHALL BE ARRANGED FOR A LEFT-HAND ( CLEARANCE: CLEARANCES AROUND WATER CLOSETS AND IN TOII 1 SIZE: CLEARANCE AROUND A WATER CLOSET SHALL BE 60 INCHI	D OR RIGHT-I OILET COMP
AUM MEASURED PERPENDICULAR FROM THE REAR WALL. IVERLAP: THE REQUIRED CLEARANCE AROUND THE WATER CL ENSERS, SANITARY NAPKIN DISPOSAL UNITS, COAT HOOKS, SH	CLOSET SHA
OTHER FIXTURES, AND THE TURNING SPACE. NO OTHER FIXTURES 04.4 SEAT: THE SEAT HEIGHT OF A WATER CLOSET ABOVE THE FINISH	ES OR OBSTI SH FLOOR SI
TOP OF THE SEAT. SEATS SHALL NOT BE SPRUNG TO RETURN TO A 04.5 GRAB BARS: GRAB BARS FOR WATER CLOSETS SHALL COMPLY W CLOSET AND ON THE REAR WALL. 04.5.1 SIDE WALL: THE SIDE WALL GRAB CAR SHALL BE 42 INCHES LON	( WITH 609. (
54 INCHES MINIMUM FROM THE REAR WALL. 604.5.2 REAR WALL: THE REAR WALL GRAB BAR SHALL BE 36 INCHES LC MINIMUM ON ONE SIDE AND 24 INCHES MINIMUM ON THE OTHER SID	
604.6 FLUSH CONTROLS: FLUSH CONTROLS SHALL BE HAND OPERATED CONTROLS SHALL BE LOCATED ON THE OPEN SIDE OF THE WATER 604.7 DISPENSERS: TOILET PAPER DISPENSERS SHALL COMPLY WITH 3	R CLOSET E
WATER CLOSET MEASURED TO THE CENTERLINE OF THE DISPENSE MAXIMUM ABOVE THE FINISH FLOOR AND SHALL NOT BE LOCATED E THAT DOES NOT ALLOW CONTINUOUS PAPER FLOW.	D BEHIND GF
04.8.1.5 GRAB BARS : GRAB BARS SHALL COMPLY WITH 609. A SIDE-W/ ON THE WALL CLOSEST TO THE WATER CLOSET. IN ADDITION, A RE 04.8.3 COAT HOOKS AND SHELVE: COAT HOOKS SHALL BE LOCATED V	REAR-WALL ( O WITHIN ONE
INCHES MINIMUM AND 48 INCHES MAXIMUM ABOVE THE FINISH FLOO 05.4 FLUSH CONTROLS: FLUSH CONTROLS SHALL BE HAND OPERATED 06 LAVATORIES AND SINKS	
606.1 GENERAL: LAVATORIES AND SINKS SHALL COMPLY WITH 606 606.2 CLEAR FLOOR SPACE: A CLEAR FLOOR SPACE COMPLYING WITH 3 COMPLYING WITH 306 SHALL BE PROVIDED.	H 305, POSIT
<ul> <li>506.3 HEIGHT: LAVATORIES AND SINKS SHALL BE INSTALLED WITH THE I ABOVE THE FINISH FLOOR OR GROUND</li> <li>506.4 FAUCETS: CONTROLS FOR FAUCETS SHALL COMPLY WITH 309. H/</li> </ul>	
606.5 EXPOSED PIPES AND SURFACE: WATER SUPPLY AND DRAIN PIPE: CONFIGURED TO PROTECT AGAINST CONTACT. THERE SHALL BE N 609 GRAB BARS	PES UNDER
GENERAL: GRAB BARS IN TOILET FACILITIES AND BATHING FACILI CROSS SECTION: GRAB BARS SHALL HAVE A CROSS SECTION CON I CIRCULAR CROSS SECTIO: GRAB BARS WITH CIRCULAR CROSS	OMPLYING W
XIMUM. 2 NON-CIRCULAR CROSS SECTIO: GRAB BARS WITH NON-CIRCULA XIMUM AND A PERIMETER DIMENSION OF 4 INCHES MINIMUM AND SPACINC: THE SPACE BETWEEN THE WALL AND THE GRAB BAR SH	ND 4.8 INCH
ND AT THE ENDS SHALL BE 1 ½ INCHES MINIMUM. THE SPA	
ALL BE INSTALLED IN A HORIZONTAL POSITION 18 INCHES N RIPPING SURFACE. THE HEIGHT OF THE LOWER GRAB BA CE HAZARDS: GRAB BARS AND ANY WALL OR OTHER SURFA L HAVE ROUNDED EDGES	BAR ON T
SE GRAB BARS SHALL NOT ROTATE WITHIN THEIR FITTINGS LATIOI: GRAB BARS SHALL BE INSTALLED IN ANY MANNER	
BSTRUCT THE REQUIRED CLEAR FLOOR SPACE	

# GS AND FACILITIES - BASED ON THE FOR ACCESSIBLE DESIGN

INTS FOR ACCESSIBILITY TO SITES, FACILITIES, BUILDINGS, AND ELEMENTS BY ING THE DESIGN, CONSTRUCTION, ADDITIONS TO, AND ALTERATIONS OF EGULATIONS ISSUED BY FEDERAL AGENCIES UNDER THE AMERICANS WITH

206 AND SHALL COMPLY WITH CHAPTER 4

RED BY 206.2 DED WITHIN THE SITE FROM ACCESSIBLE PARKING SPACES AND ACCESSIBLE RANSPORTATION STOPS TO THE ACCESSIBLE BUILDING OR FACILITY ENTRANCE

SIBLE BUILDINGS, ACCESSIBLE FACILITIES, ACCESSIBLE ELEMENTS, AND

HE SAME AREA AS GENERAL CIRCULATION PATHS. WHERE CIRCULATION ENTRANCE DOORS, DOORWAYS, AND GATES SHALL COMPLY WITH 404 AND

OUGH 206.4.9, AT LEAST 60 PERCENT OF ALL PUBLIC ENTRANCES SHALL

SIBLE ROUTE SHALL COMPLY WITH 404 RWAYS AND MANUAL GATS INTENDED FOR USER PASSAGE SHALL

F DOORWAYS WITH TWO LEAVES SHALL COMPLY WITH 404.2.3 AND 404.2.4 HES MINIMUM. CLEAR OPENINGS OF DOORWAYS WITH SWINGING DOORS THE DOOR OPEN 90 DEGREES. OPENINGS MORE THAN 24 INCHES DEEP SHALL JECTIONS INTO THE REQUIRED CLEAR OPENING WIDTH LOWER THAN 34 ENING WIDTH BETWEEN 34 INCHES AND 80 INCHES ABOVE THE FINISH FLOOR

ORS AND GATS SHALL COMPLY WITH 404.2.4 MANEUVERING CLEARANCES SIDE OR HINGE SIDE CLEARANCE. MANEUVERING CLEARANCES COMPLYING WITH TABLE 404.2.4.1 DOC: DOORWAYS LESS THAN 36 INCHES WIDE WITHOUT DOORS OR

ANCES COMPLYING WITH TABLE 404.2.4.2 JIRED MANEUVERING CLEARANCES SHALL COMPLY WITH 302. CHANGES IN

HIGH MAXIMUM. RAISED THRESHOLDS AND CHANGES IN LEVEL AT

GED OR PIVOTED DOORS IN SERIES AND GATES IN SERIES SHALL BE 48 SPACE. R OPERABLE PARTS ON DOORS AND GATES SHALL COMPLY WITH 309.4. ICHES MAXIMUM ABOVE THE FINISH FLOOR OR GROUND WHERE SLIDING

E EXPOSED AND USABLE FROM BOTH SIDES. 4.2.8 SHALL BE ADJUSTED SO THAT FROM AN OPEN POSITION OF 90 DEGREES,

I THE LATCH IS 5 SECONDS MINIMUM N 10 INCHES OF THE FINISH FLOOR OF GROUND MEASURED VERTICALLY TH OF THE DOOR OR GATE. PARTS CREATING HORIZONTAL OR VERTICAL E OTHER. CAVITIES CREATED BY ADDED KICK PLATES SHALL BE CAPPED. GATES, CONTAINING ONE OR MORE GLAZING PANELS THAT PERMIT EAZED PANEL LOCATED 43 INCHES MAXIMUM ABOVE THE FINISHED FLOOR.

### O WITHIN THE ROOM

ND TURNING SPACES SHALL BE PERMITTED TO OVERLAP. R CLEARANCE REQUIRED FOR ANY FIXTURE. DOORS SHALL BE PERMITTED TO

BE INSTALLED WITH THE BOTTOM EDGE OF THE REFLECTING SURFACE 40 CATED ABOVE LAVATORIES OR COUNTERTOPS SHALL BE INSTALLED WITH THE FINISH FLOOR OR GROUND. THE REACH RANGES SPECIFIED IN 308. SHELVES SHALL BE LOCATED 40

TH 604.2 THROUGH 604.8

TITION TO THE REAR AND TO ONE SIDE. THE CENTERLINE OF THE WATER WALL OR PARTITION, EXCEPT THAT THE WATER CLOSET SHALL BE 17 N IN THE AMBULATORY ACCESSIBLE TOILET COMPARTMENT SPECIFIED IN AND APPROACH

RTMENTS SHALL COMPLY WITH 604.3 MEASURED PERPENDICULAR FROM THE SIDE WALL AND 56 INCHES

BE PERMITTED TO OVERLAP THE WATER CLOSET, ASSOCIATED GRAB BARS, ESSIBLE ROUTES, CLEAR FLOOR SPACES AND CLEARANCES REQUIRED AT JCTIONS SHALL BE LOCATED WITHIN THE REQUIRED WATER CLOSET CLEARANCE. ALL BE 17 INCHES MINIMUM AND 19 INCHES MAXIMUM MEASURED TO THE SITION AB BARS SHALL BE PROVIDED ON THE SIDE WALL CLOSEST TO THE WATER

LOCATED 12 INCHES MAXIMUM FROM THE REAR WALL AND EXTENDING

M AND EXTEND FROM THE CENTERLINE OF THE WATER CLOSET 12 INCHES

ATIC. HAND OPERATED FLUSH CONTROLS SHALL COMPLY WITH 309. FLUSH CEPT IN AMBULATORY ACCESSIBLE COMPARTMENTS COMPLYING WITH 604.8.2 ALL BE 7 INCHES MINIMUM TO 9 INCHES MAXIMUM IN FRONT OF THE LET OF THE DISPENSER SHALL BE 15 INCHES MINIMUM AND 48 INCHES B BARS. DISPENSERS SHALL NOT BE A TYPE THAT CONTROLS DELIVERY OR

AR COMPLYING WITH 604.5.1 SHALL BE PROVIDED AND SHALL BE LOCATED RAB BAR COMPLYING WITH 604.5.2 SHALL BE PROVIDED OF THE REACH RANGES SPECIFIED IN 308. SHELVES SHALL BE LOCATED 40

ATIC. HAND OPERATED FLUSH CONTROLS SHALL COMPLY WITH 309

NED FOR A FORWARD APPROACH, AND KNEE AND TOE CLEARANCE HE HIGHER OF THE RIM OR COUNTER SURFACE 34 INCHES MAXIMUM

ED METERING FAUCETS SHALL REMAIN OPEN FOR 10 SECONDS MINIMUM. VATORIES AND SINKS SHALL BE INSULATED OR OTHERWISE BRASIVE SURFACES UNDER LAVATORIES AND SINKS.

### COMPLY WITH 609

H 609.2.1 OR 609.2.2 SHALL BE AN OUTSIDE DIAMETER OF 1 ¼ INCHES MINIMUM AND 2 INCHES


ECTIONS SHALL HAVE A CROSS-SECTION DIMENSION OF 2 INCHES MAXIMUM.

INCHES. THE SPACE BETWEEN THE GRAB BAR AND PROJECTING OBJECTS N THE GRAB BAR AND PROJECTING OBJECTS ABOVE SHALL BE 12 INCHES

POSITION, 33 INCHES MINIMUM AND 36 INCHES MAXIMUM ABOVE THE AT AT WATER CLOSETS FOR CHILDREN'S USE COMPLYING WITH 604.9, GRAB D 27 INCHES MAXIMUM ABOVE THE FINISH FLOOR MEASURED TO THE TOP ACK WALL OF A BATHTUB SHALL COMPLY WITH 607.4.1.1 OR 607.4.2.1 ENT TO GRAB BARS SHALL BE FREE OF SHARP OR ABRASIVE ELEMENTS


IDES A GRIPPING SURFACE AT THE SPECIFIED LOCATIONS AND THAT DOES OR MATERIALS USED WHEN A VERTICAL OR HORIZONTAL FORCE OF 250 EVICE, OR SUPPORTING STRUCTURE.


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BRINCE GEORGE'S COUNTY, MD PRINCE GEORGE'S COUNTY, MD DA ACCESSIBILITY REQUIREMENTS		E S 1 Leesburg Pike   Suita 22182 P: 571.830.1800   F: www.Lessardde SEAL & SIGNA	e 700   Vienna, VA 571.830.1801 esign.com
SUITLAND RETAIL KIOSK PRINCE GEORGE'S COUNTY, MD DA ACCESSIBILITY REQUIREMENT	PR	REDEVELOP	PEMENT
	PROJECT NAME:	SUITLAND RETAIL KIOSK PRINCE GEORGE'S COUNTY, MD	ADA ACCESSIBILITY REQUIREMENT

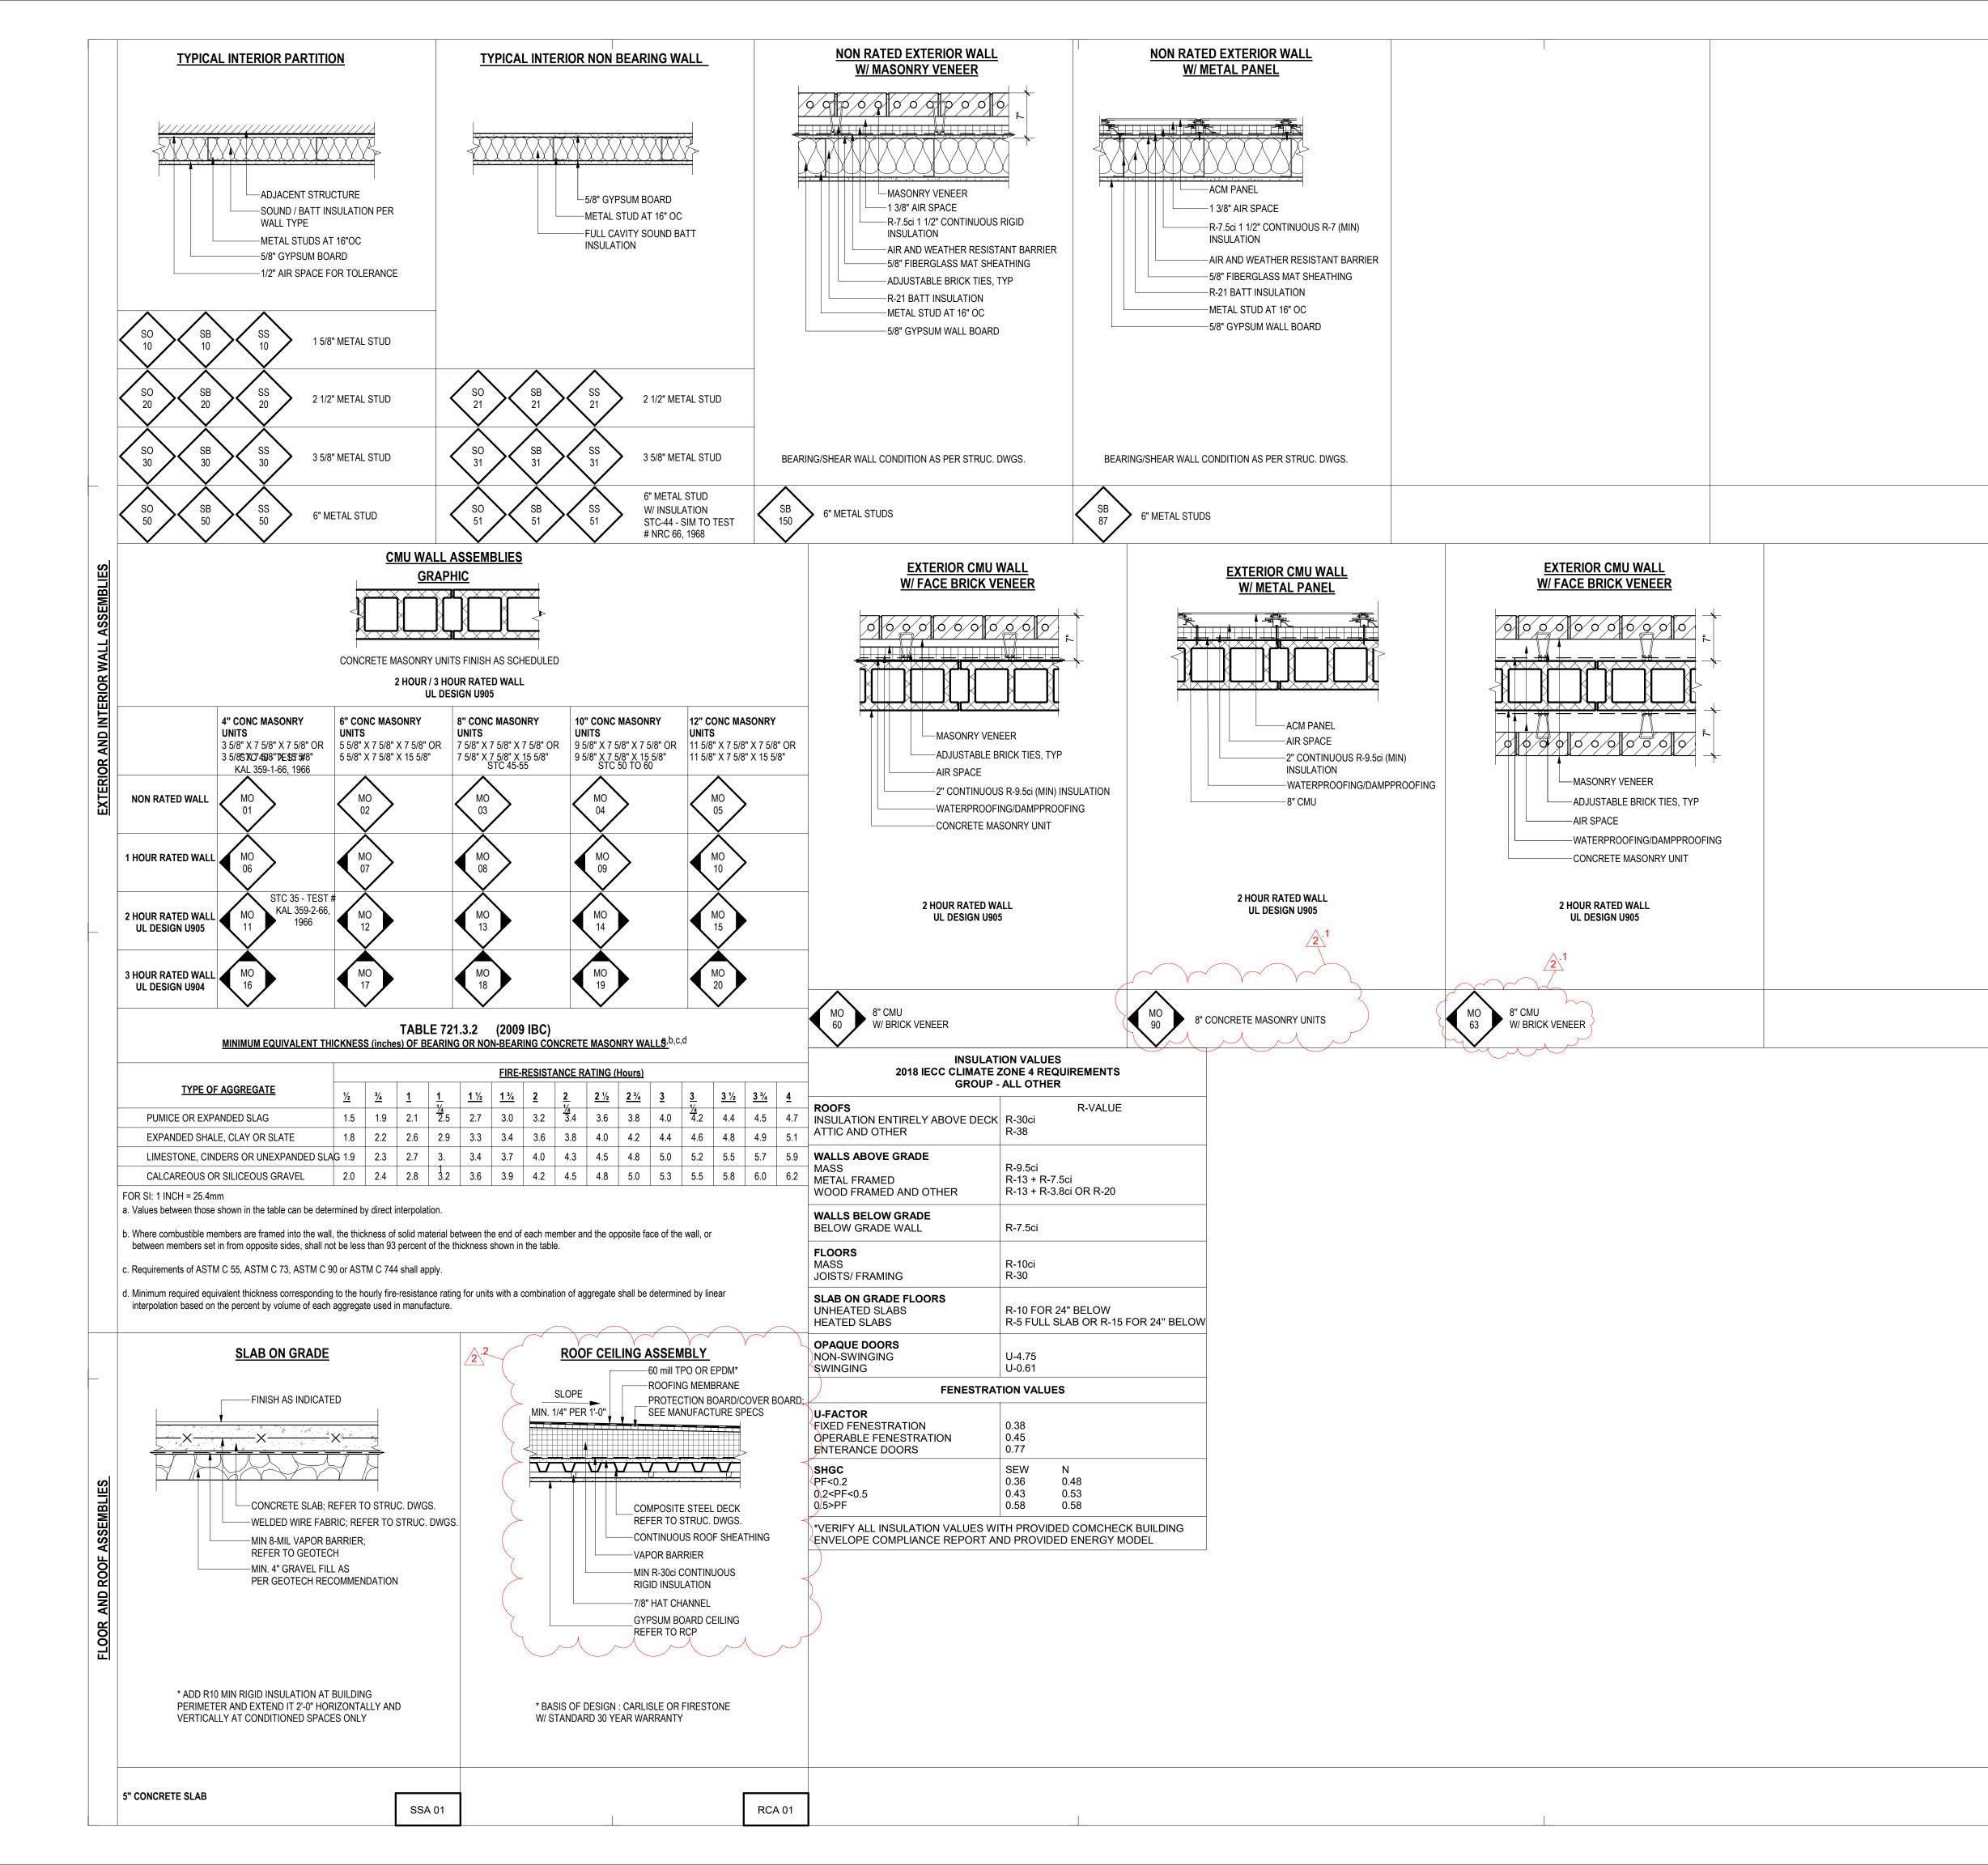

ASSOCIATION 5/8" TYPE "X" GYPSUM BOA ASSEMBLIES, GA FILES ASSEMBLIES. B. EXTERIOR WALL PARTITION: 1. CONSULT WITH VENEER MANUFACTUR ANY ADDITIONAL WALL REQUIREMENTS. C. INTERIOR NON-RATED WALL: 1. INTERIOR PARTITION STUDS SPACED A D. FIRE RATED WALLS: 1. FIRE RESISTANCE DIRECTORY TO BE E FILES ASSEMBLIES. 2. WHEN NON-RATED FIRE WALLS INTERS CONSTRUCTION OF RATED WALLS THRO 3. IF RATED WALL OCCURS BEHIND PLUM BOARD BEFORE FIXTURES. 4. EXTEND FIRE RATED PARTITIONS FROI FLOOR OR ROOF DECK ABOVE AND COVI SEAL AT BOTTOM AND TOP. 5. PROVIDE FIRE STOPPING AT PENETRA ELECTRICAL OUTLETS ON OPPOSITE SID SPACE IS NOT ALLOWED. E. SOUND INSULATED WALLS: 1. FIRE RESISTANCE SOUND CONTROL D ASSOCIATIONS. 2. PROVIDE CONTINUOUS 3 1/2" SOUND IN MECHANICAL ROOMS. 3. PROVIDE CONTINUOUS 3 1/2" SOUND IN MECHANICAL ROOMS. 5. STAGGER CUTOUTS FOR ELECTRICAL INSULATION TO PASS AROUND BOXES AT 6. GYPSUM ASSOCIATION FIRE RESISTAN F. BLOCKING: 1. PROVIDE SOLID BLOCKING OR METAL S BOARD	AT MAXIMUM OF 16" ON CENTER (O.C.) BY UNDERWRITERS LABORATORIES, INC. GA SECT FIRE RATED WALLS; CARRY DUGH. MBING INSTALLATION, INSTALL GYPSUM OM FLOOR SLAB TO UNDERSIDE OF FER W/ TYPE 'X' GYP BOARD FULL HEIGHT. ATION OF FIRE RATED WALLS. CUTOUTS FOR DES OF FIRE RATED WALLS. CUTOUTS FOR DESIGN MANUAL TO BE BY GYPSUM NSULATION IN STUD WALLS ENCLOSING NSULATION IN TENANT SEPARATION WALLS. NSULATION IN TENANT SEPARATION WALLS. NSULATION IN WALLS SEPARATING UNITS SWITCHES AND OUTLETS TO ALLOW SOUND T INSULATED WALLS. NT & SOUND CONTROL DESIGN MANUAL. STRAPPING IN AREAS BEHIND GYPSUM BATHROOM ACCESSORIES, STAIR RAILINGS, ND OTHER WALL MOUNTED ITEMS.	<image/> <section-header><section-header><section-header><section-header><text><text></text></text></section-header></section-header></section-header></section-header>
WB 65         1ST LETTER INDICATES STRUCTURAL MATERIAL MASONRY UNIT (CMU)         S       METAL STUD         M       MASONRY UNIT (CMU)         C       CONCRETE         F       FURRING PARTITION         O       NO INSULATION         B       BATT INSULATION         S       SOUND INSULATION         CORNER SHADING INDICATES FIRE RATING	FLOOR ASSEMBLY   FCA 20   NAMING CONVENTION   FCA	OWNER: PRINCE GEORGE'S COUNTY REDEVELOPEMENT AUTHORITY
3         CORNER	WOOD STUD WOOD STUD WOOD STUD WOOD STUD WOOD STUD MASONRY WALL MASONRY WALL METAL STUD METAL STUD METAL STUD METAL STUD METAL STUD METAL STUD METAL STUD	PROJECT NAME: PROJECT NAME: PROJECTICAND RETAIL KIOSK PRINCE GEORGE'S COUNTY, MD PRINCE GEORGE'S COUNTY, MD PRIETTILE: PRIETTILE: P
REVISION #2 SUMMAR 1 WALL TYPE UPDATED 2 ROOF ASSEMBLY UPDATE	_	2 REVISION 2 - RFI RESPONSE 08.14.2023 PERMIT SET 12.21.2022 FOUNDATION PERMIT SET 06.20.2022 NO. DESCRIPTION DATE PROJECT NO: CJR.001A.00D DRAWN BY: Author CHECKED BY: Checker PLOT DATE: 9/1/2023 9:57:44 AM FILE NAME: GG-0300

	T	
<u> </u>		
$\vdash$		
		INSIDE CORNER
		BASE FLASHING CUT AND FOLD OVER AT CORNER
<u> </u>		USE MEMBRANE PATCH WITH LAP SEALANT TO ENSURE SEAL
		USE LIQUID MEMBRANE PATCH AT CORNER TO ENSURE SEAL
		ENSURE SEAL NOTE: PRIME ALL SUBSTR ADHERING ANY FL
		7 FLASHING AT INSI G-046 Scale: 3" = 1'-0"

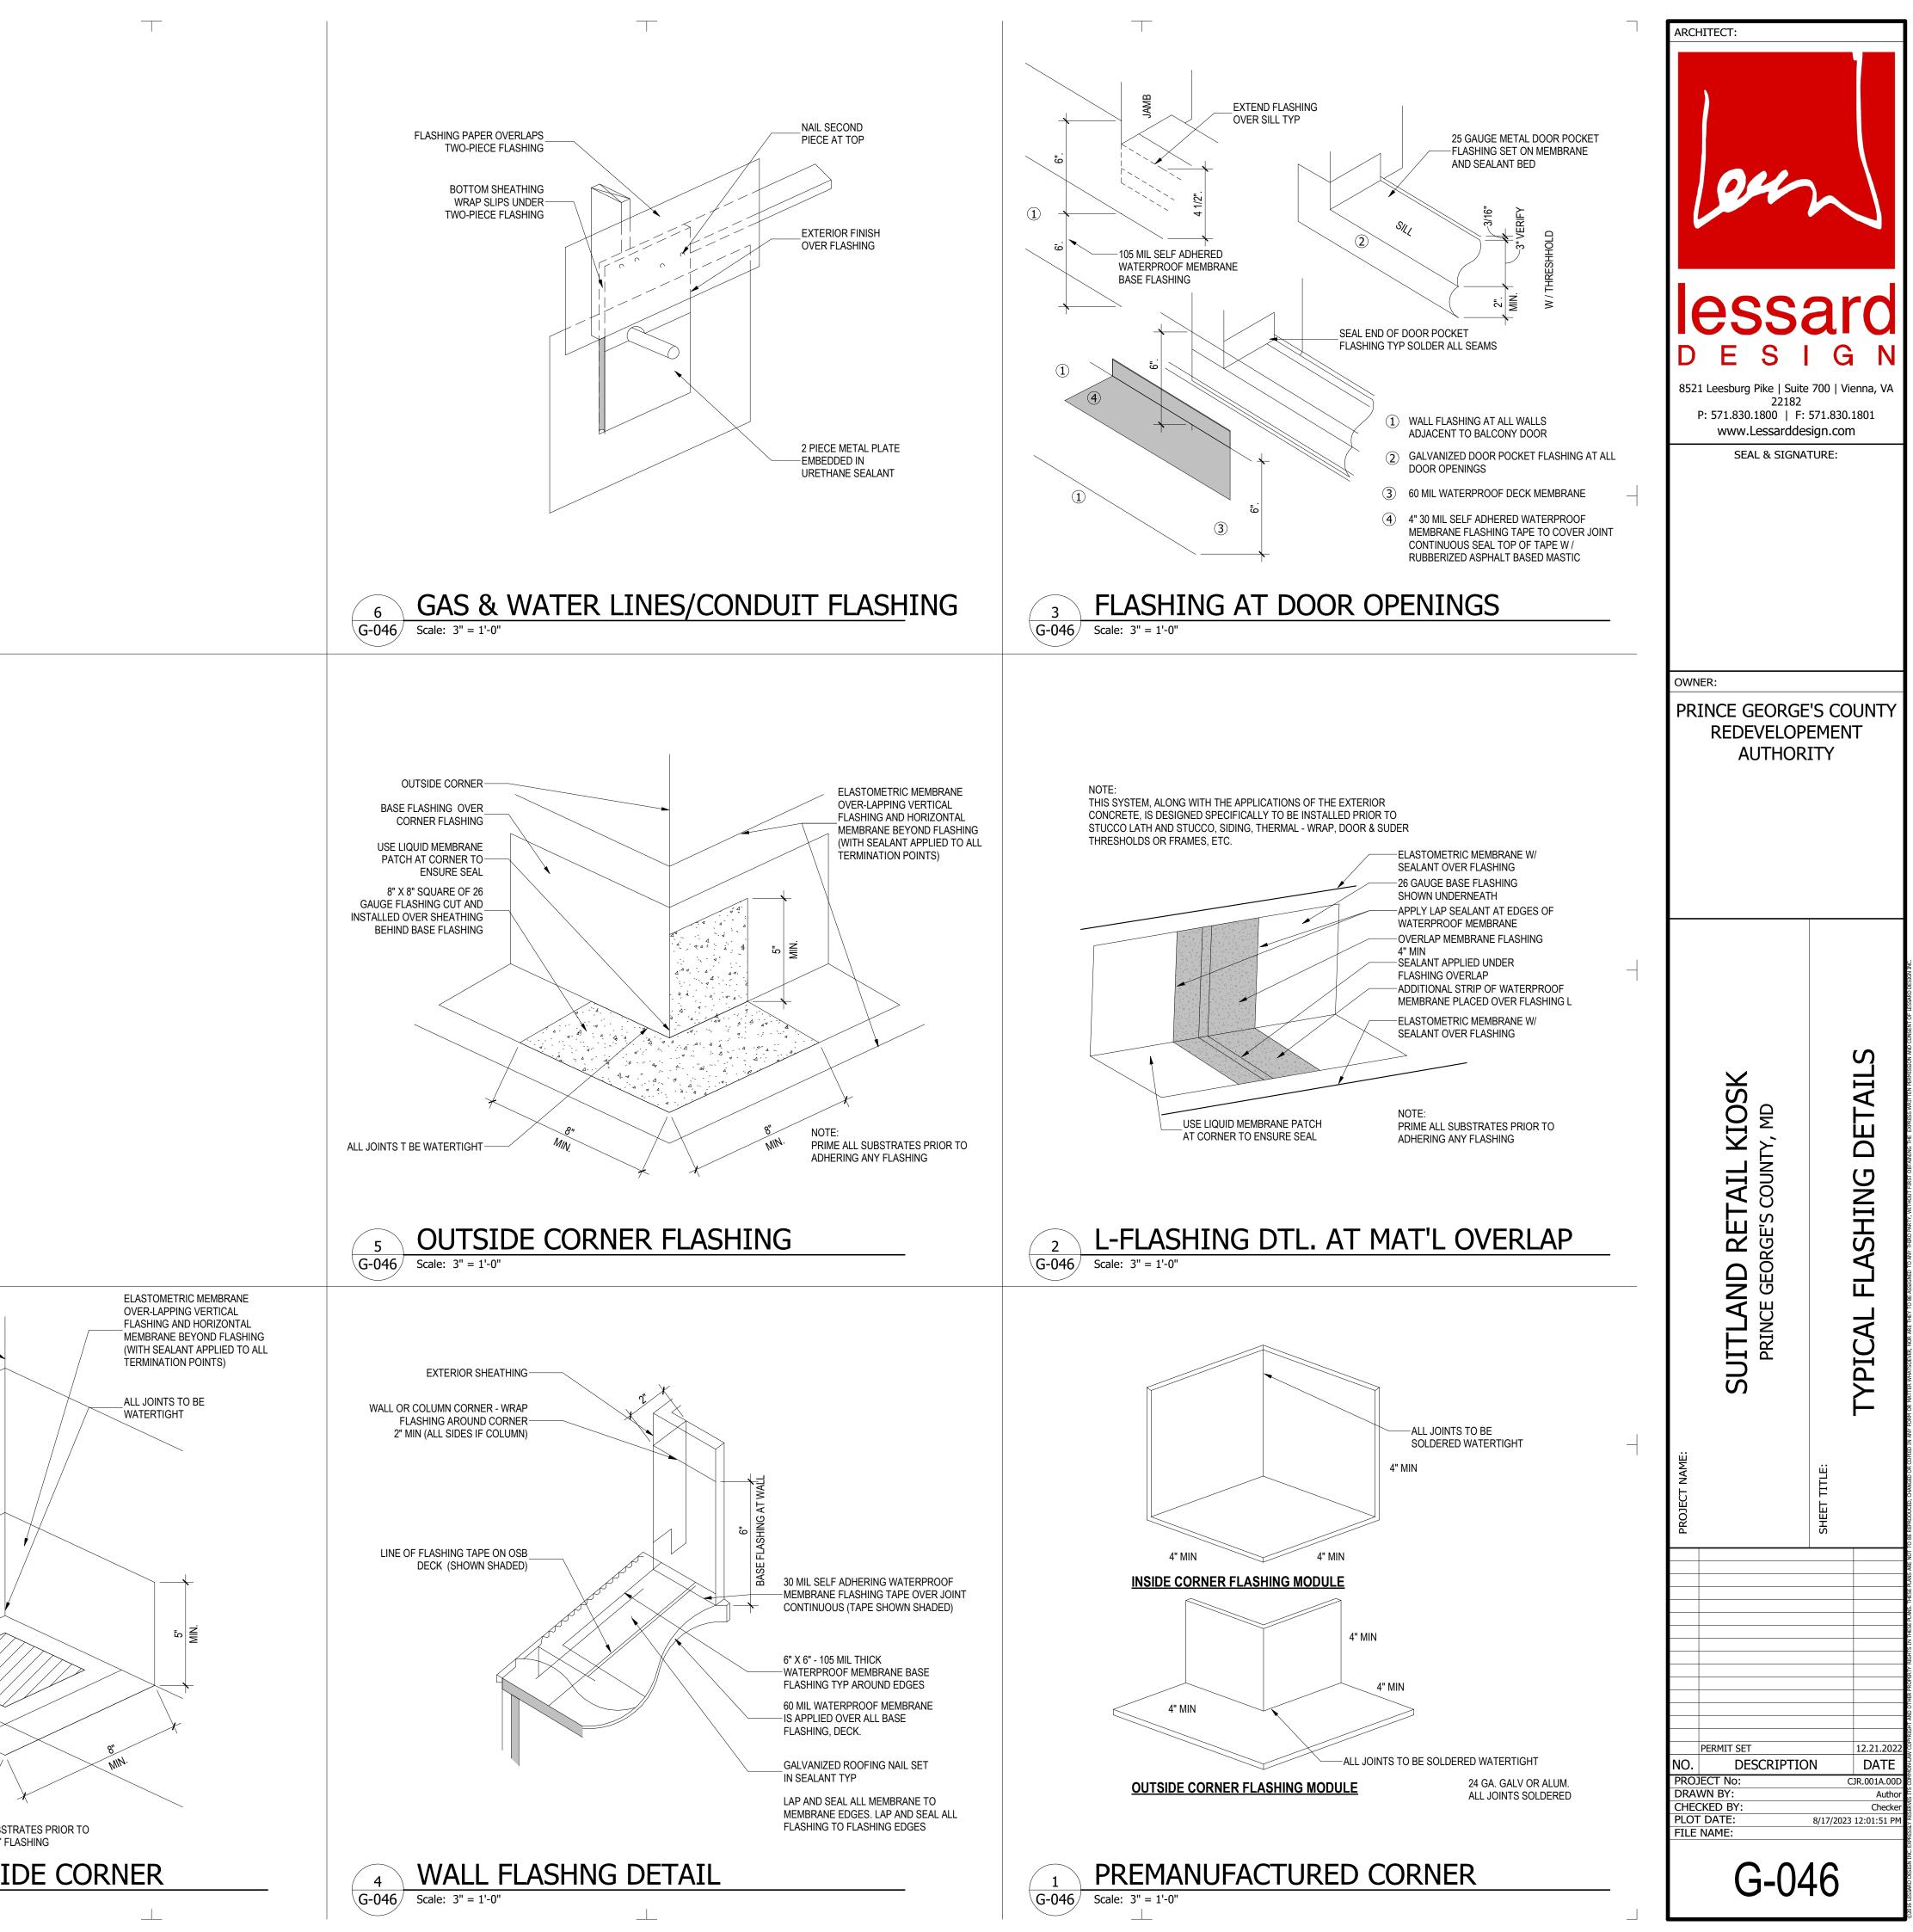

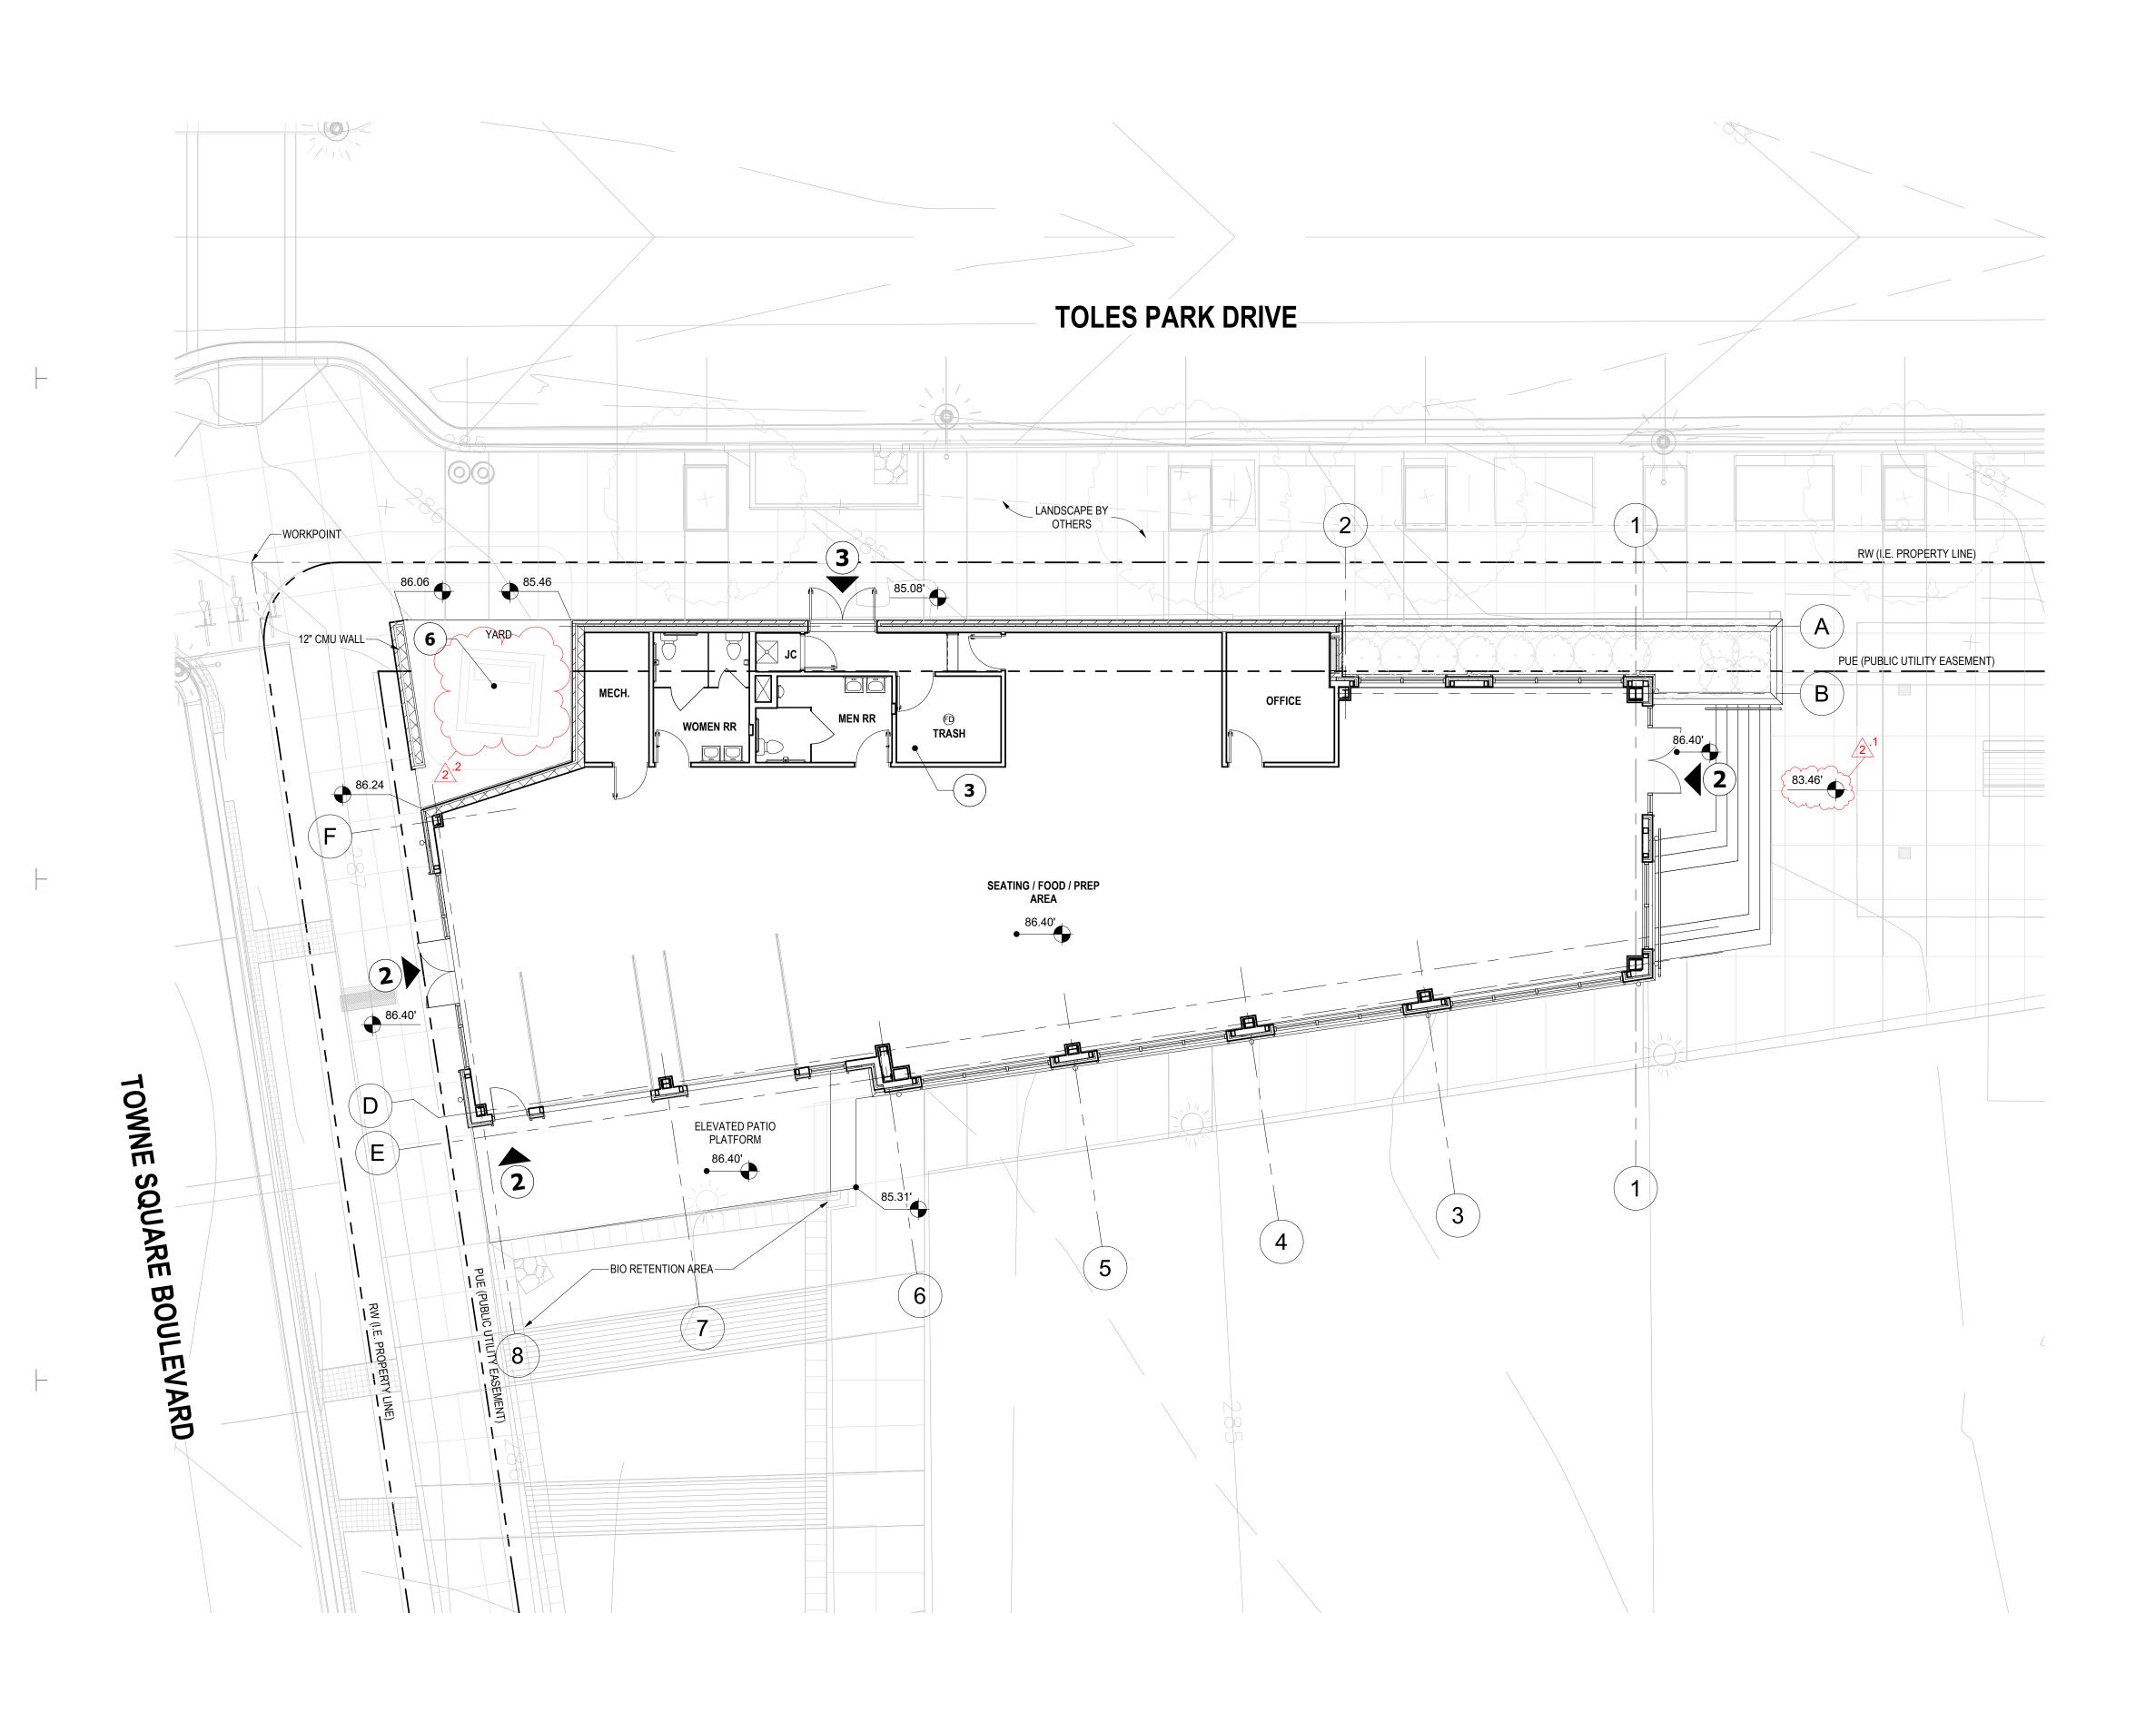



16'-0'

### KEYNOTES:

- 1 ELECTRICAL EQUIPMENTS SEE CIVIL DRAWINGS
- 2 CUSTOMER ENTRANCE / EXIT
- (3) MECHANICAL ROOM/BOH ENTRANCE
- (4) FIRE DEPARTMENT CONNECTION. PROVIDE KNOX LOCKING FDC PLUG AND CAP (STAINLESS STEEL FINISH)
- 5 FIRE HYDRANT
- 6 TRANSFORMER

### **REVISION #2 SUMMARY**


.1 BOTTOM OF STEP FINISH LEVEL COORDINATED WITH CIVIL .2 ADJUSTED TRANSFORMER TO MATCH SURVEY


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PROJECT NAME:	SUITLAND RETAIL KIOSK PRINCE GEORGE'S COUNTY, MD		AKCHI I ECI UKAL SI I E PLAN
PROJECT NAME:	SUITLAND RETAIL KIOSK PRINCE GEORGE'S COUNTY, MD		AKCHI I ECI UKAL SI IE PLAN

TRUE NORTH

KEY PLAN

PLAN NORTH

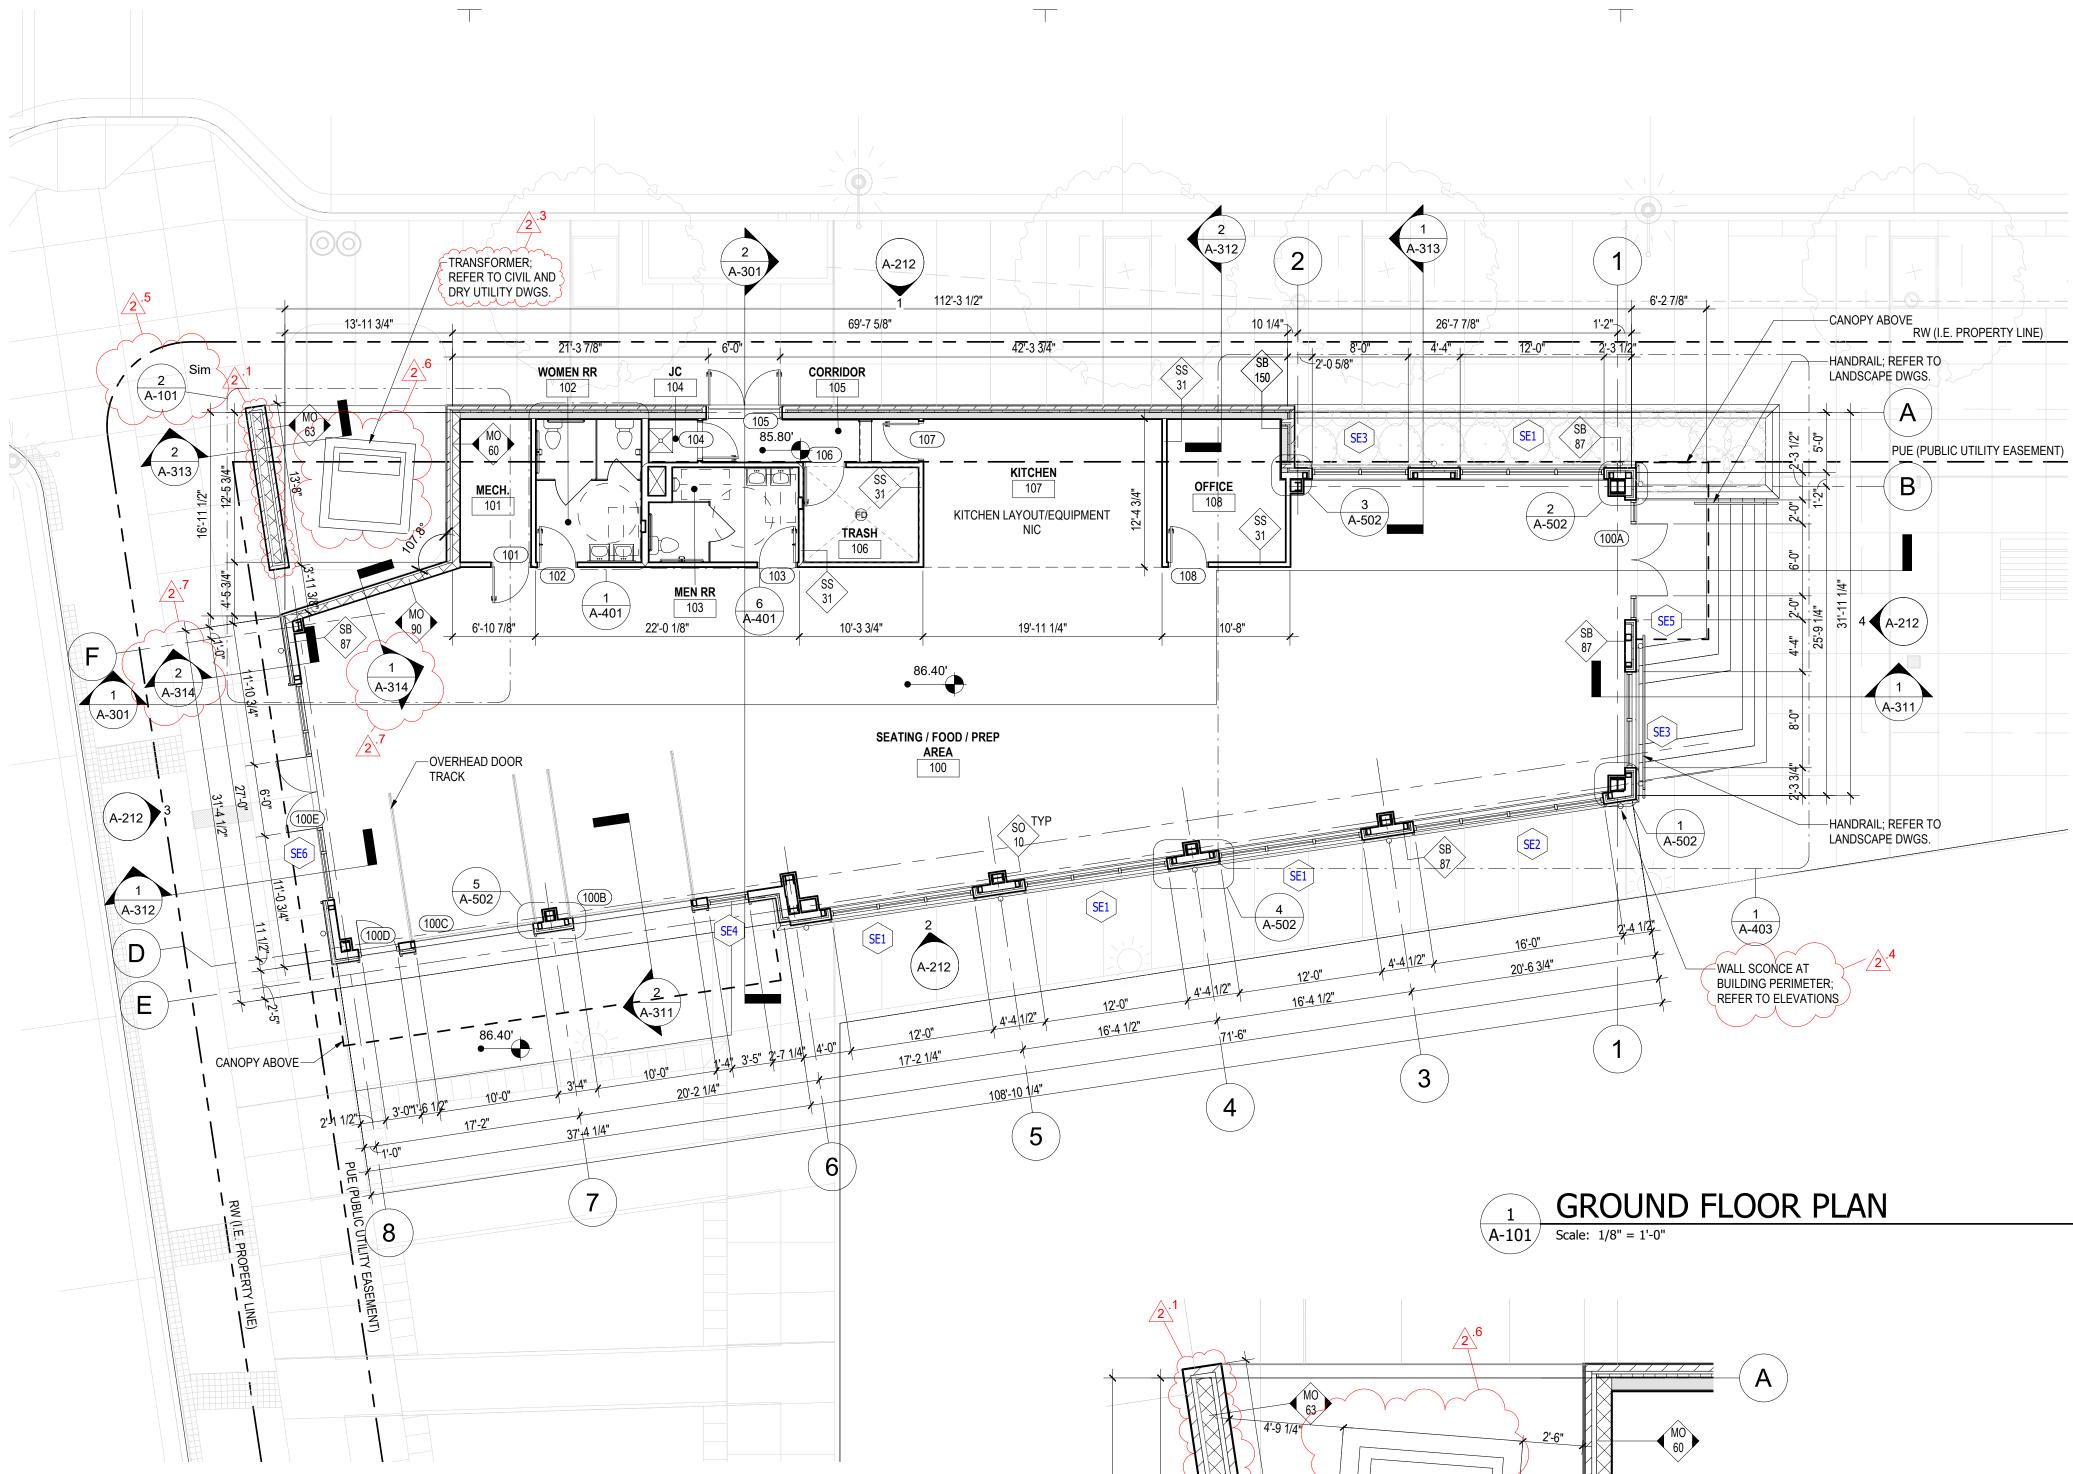


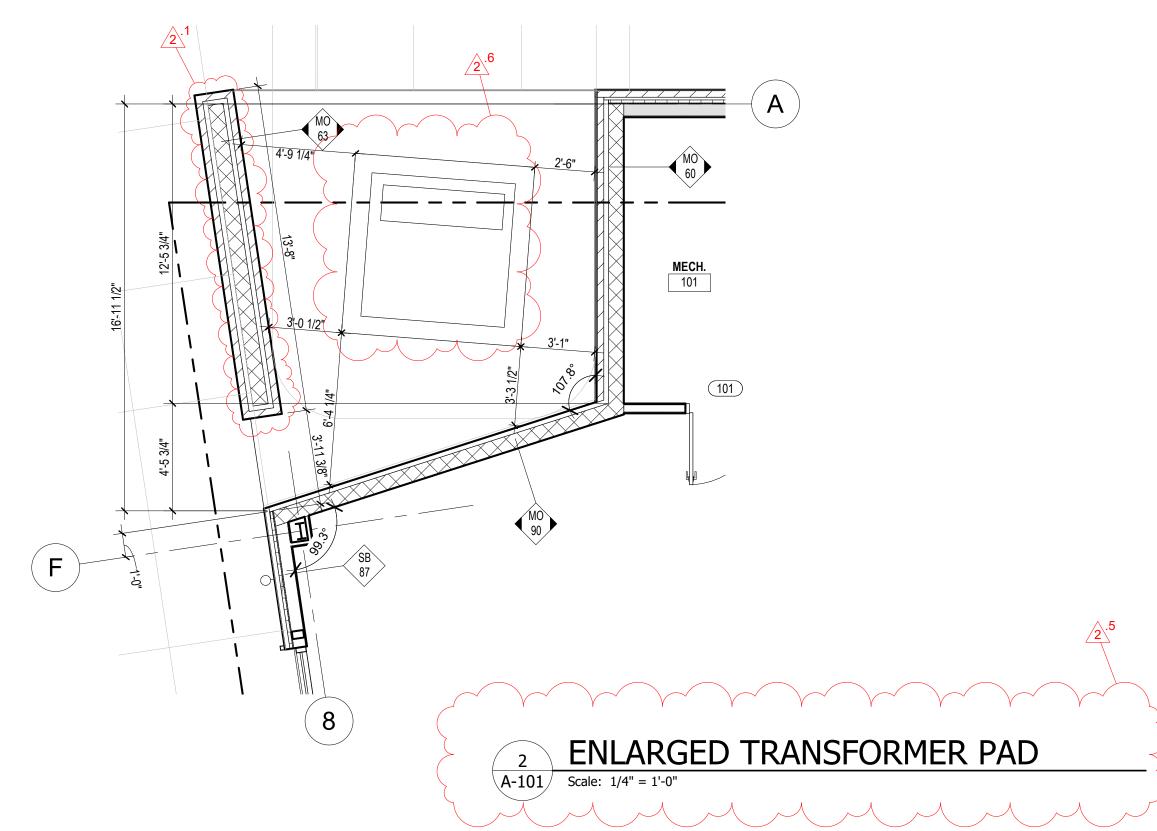

4'-0" 8'-0" SCALE: 1/8" = 1'-0"

16'-0"

BUILDING GENERAL NOTES	ARCH	HITECT:	
<ol> <li>REFER TO G-000 SERIES FOR GENERAL DETAILS AND SPECIFICATIONS.</li> <li>REFER TO SHEET G-030 FOR WALL/ FLOOR/ROOF ASSEMBLY DETAILS.</li> </ol>		)	
3. SEE A-200 SERIES FOR ELEVATIONS AND EXTERIOR WINDOW KEY REFERENCES.			
4. SEE A-300 SERIES DRAWING FOR BUILDING AND WALL SECTIONS.			
<ol> <li>SEE A-500 FOR SPECIFIC BUILDING DETAILS.</li> <li>SEE A-600 SERIES FOR SCHEDULES.</li> </ol>		Ol	
7. EXTERIOR BUILDING DIMENSIONS ARE FROM TO THE EXTERIOR FACE OF STUD OR UNFINISHED			
WALL UNLESS NOTED OTHERWISE.			
8. FINISH FLOOR : TRASH ROOM - BROOM FINISH UTILITY AREA - STANDARD TROWEL FLOATED FINISH			ard
9. PROVIDE ASHFORD FORMULA PRODUCT ON THE SOG AFTER POUR.		ess	alu
	D	E S I	GN
	8521	1 Leesburg Pike   Suite 22182	2700   Vienna, VA
REVISION #2 SUMMARY         .1 MO 63 WALL TYPE UPDATED         .2 NOTES ADDED	F	P: 571.830.1800   F: www.Lessardde	
.2 NOTES ADDED .3 TRANSFORMER NOTE UPDATED .4 WALL SCONCE AT BUILDING PERIMETER ADDED		SEAL & SIGNA	
.5 ADDED ENLARGED VIEW OF TRANSFORMER PAD AND UPDATED PER AS-BUILT FROM OWNER			
.6 ADJUSTED TRANSFORMER TO MATCH SURVEY .7 ADDED SECTIONS			
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	2 NO. PROJ DRAV CHEC PLOT	PERMIT SET FOUNDATION PERMIT SE DESCRIPTIC JECT NO: WN BY: CKED BY: DATE: NAME:	12.21.2022         T       06.20.2022         IN       DATE         CJR.001A.00D         Author         Checker         9/1/2023       9:57:40 AM
NORTH NORTH	2 NO. PROJ DRAV CHEC PLOT	PERMIT SET FOUNDATION PERMIT SE DESCRIPTIC JECT No: WN BY: CKED BY: DATE:	12.21.202         T       06.20.202         VN       DATE         CJR.001A.001         Author         Checke         9/1/2023       9:57:40 Attention

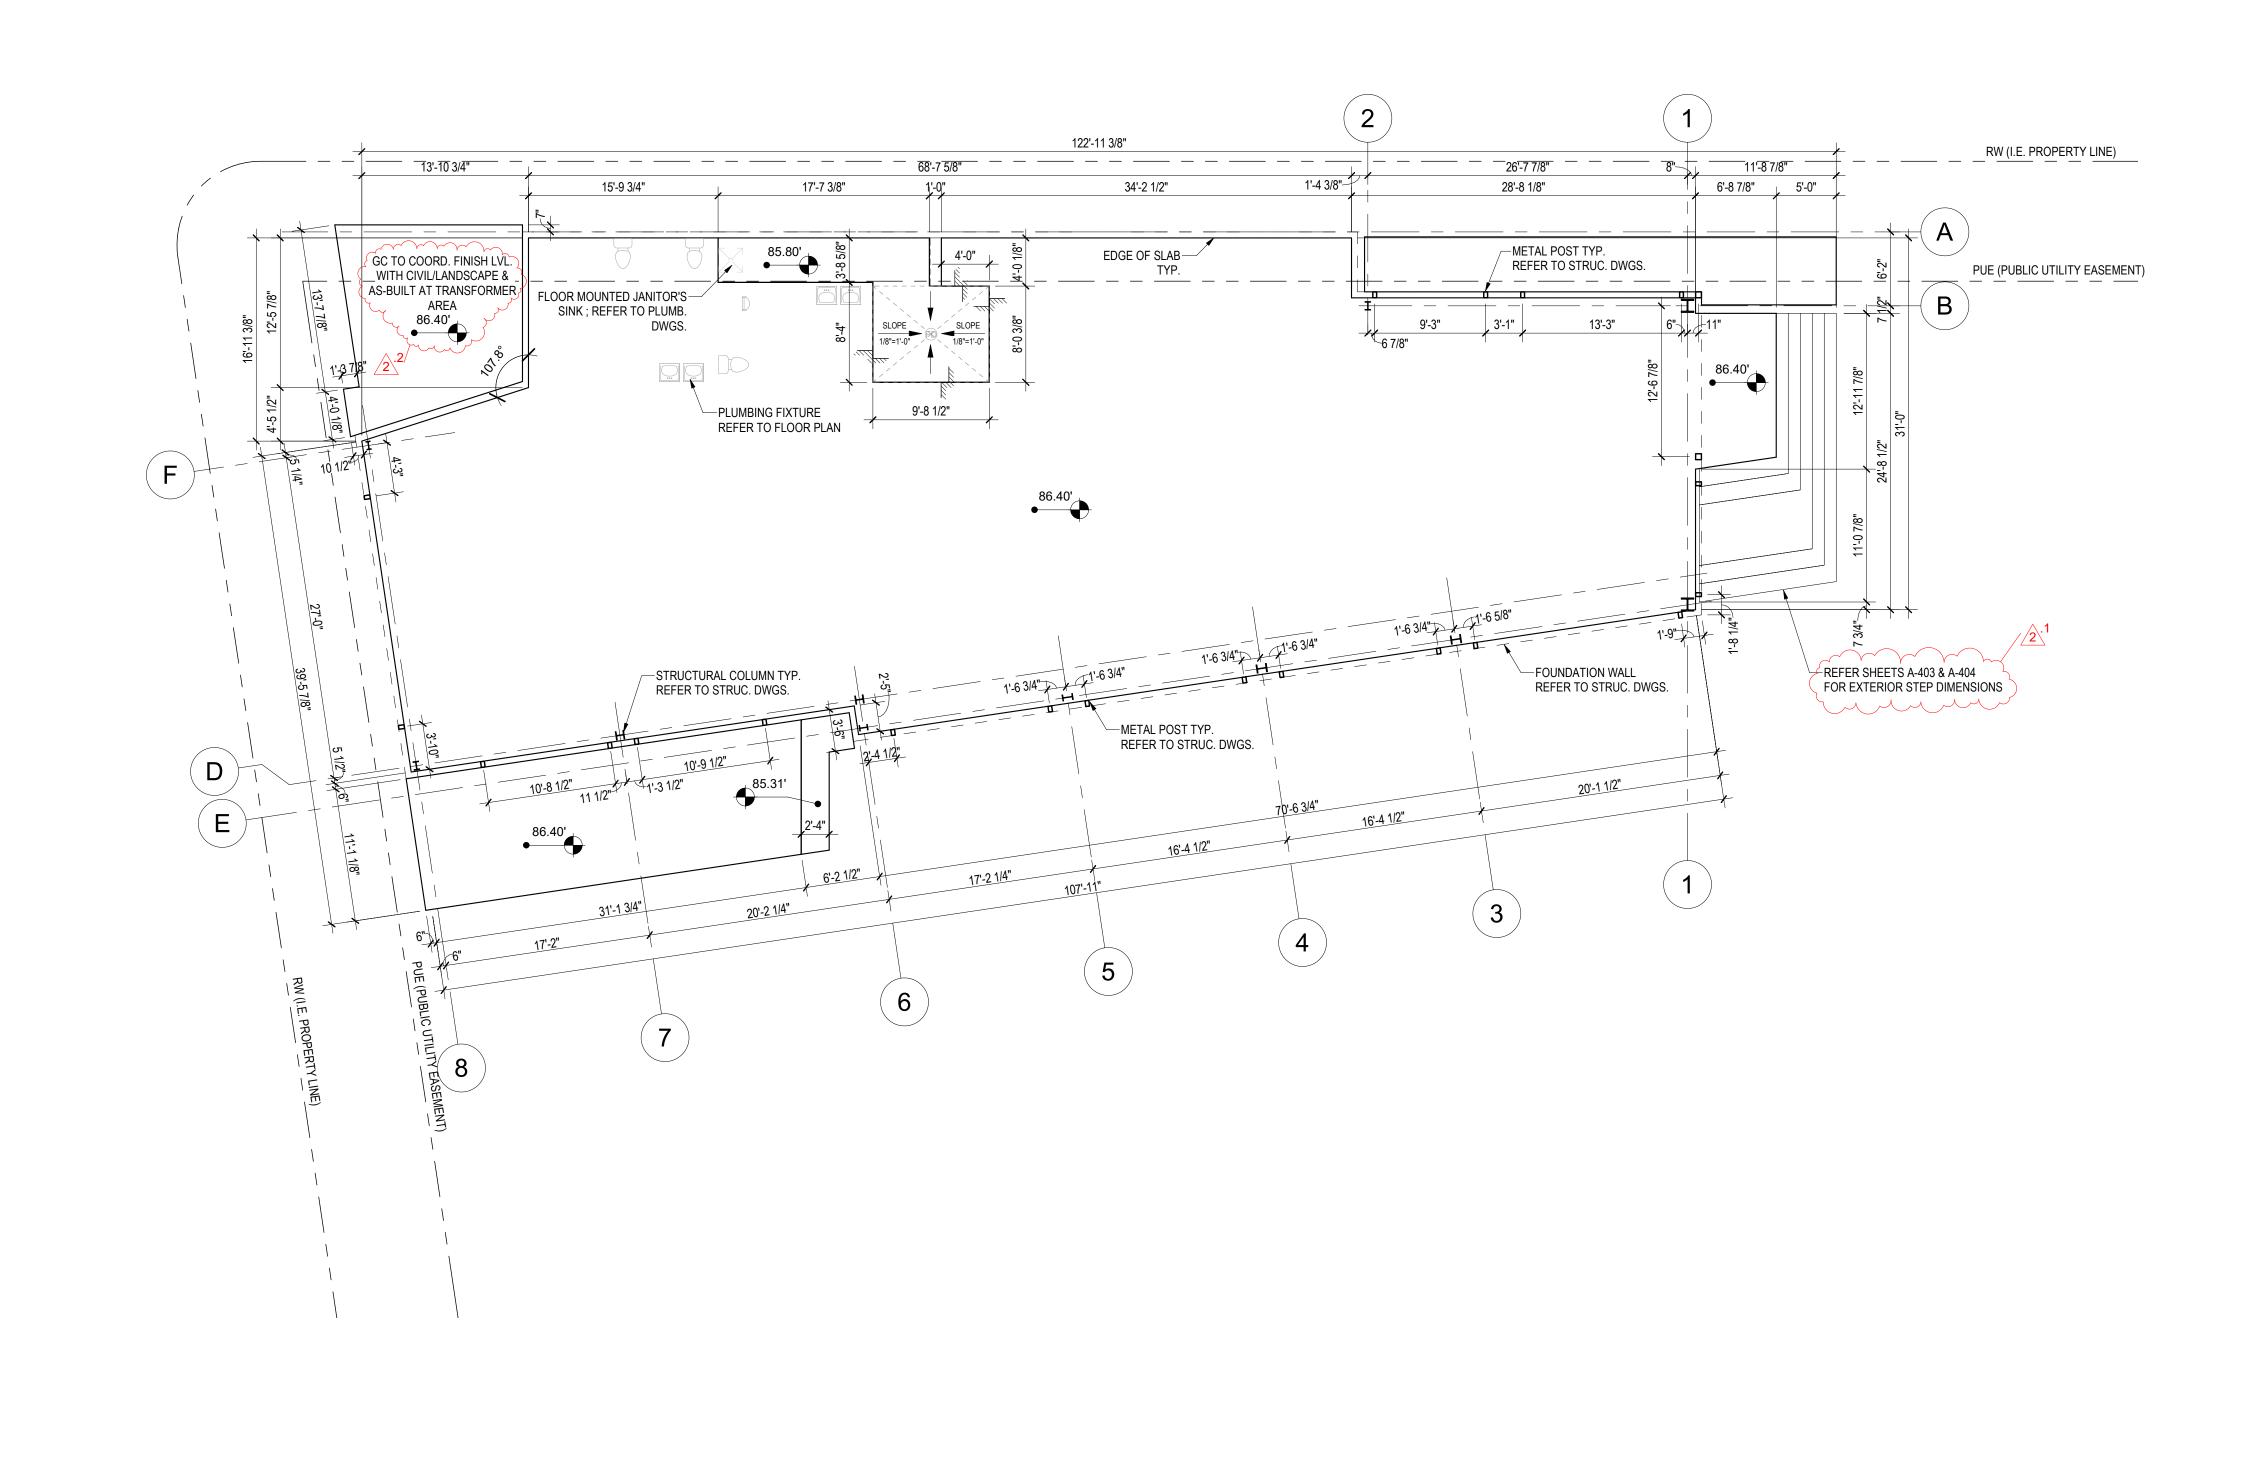

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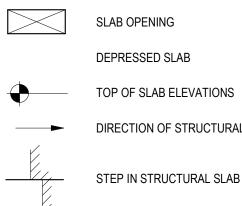


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### **SLAB EDGE PLAN GENERAL NOTES**

- GC TO REVIEW ALL FLOOR FINISHES INCLUDING ARCHITECTURAL PLANS AND INTERIOR DESIGN DRAWINGS AND PROVIDE THE REQUIRED SLAB RECESS TO ACCOMMODATE A FINISHED FLOOR WITHOUT SLOPES OR OTHER VERTICAL TRANSITIONS.
- 2. SLAB EDGE TO BE COORDINATED WITH MEP AND STRUCTURAL WORK.
- CONTRACTOR SHALL PROVIDE COORDINATION PLANS AS REQUIRED BY SPEC SECTION 01 3100.
- 4. SEE STRUCTURAL DRAWINGS FOR COLUMN AND BEAM SCHEDULES.
- DIMENSIONS ARE TO FACE OF CONCRETE, TO HOLD FACE OF COLUMNS AND TO MAIN GRID 5. LINES.
- 6. SPOT ELEVATIONS INDICATE TOP OF STRUCTURAL SLAB UNLESS OTHERWISE NOTED.
- CONTRACTOR TO COORDINATE OPENINGS IN CONCRETE WALLS FOR OPENINGS WITH 7. SCHEDULES AND MANUFACTURERS REQUIREMENTS.
- ARCHITECTURAL SLAB EDGE PLAN DIMENSIONS SUPERCEDE DIMENSIONS ON STRUCTURAL PLANS AND SHALL BE COORDINATED WITH ALL REMAINING ARCHITECTURAL PLANS 8. ACCORDINGLY.
- 9. IF NOT DIMENSIONED, COLUMNS ARE TO BE CENTERED ON THE GRID LINE SHOWN.

### SLAB EDGE PLAN LEGEND



FD RD

DEPRESSED SLAB

SLAB OPENING

DIRECTION OF STRUCTURAL SLAB SLOPE

STEP IN STRUCTURAL SLAB WITH DIMENSION INDICATED


COLUMN BELOW


PLUMBING FIXTURE, SEE PLUMBING PLANS

DRAINS, SEE PLUMBING PLANS

### **REVISION #2 SUMMARY**

.1 EXTERIOR STEP REFERENCE SHEETS INDICATED .2 TRANSFORMER AREA SLAB ON GRADE ADDED

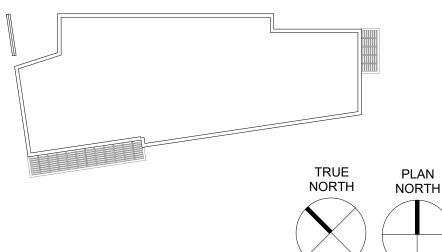

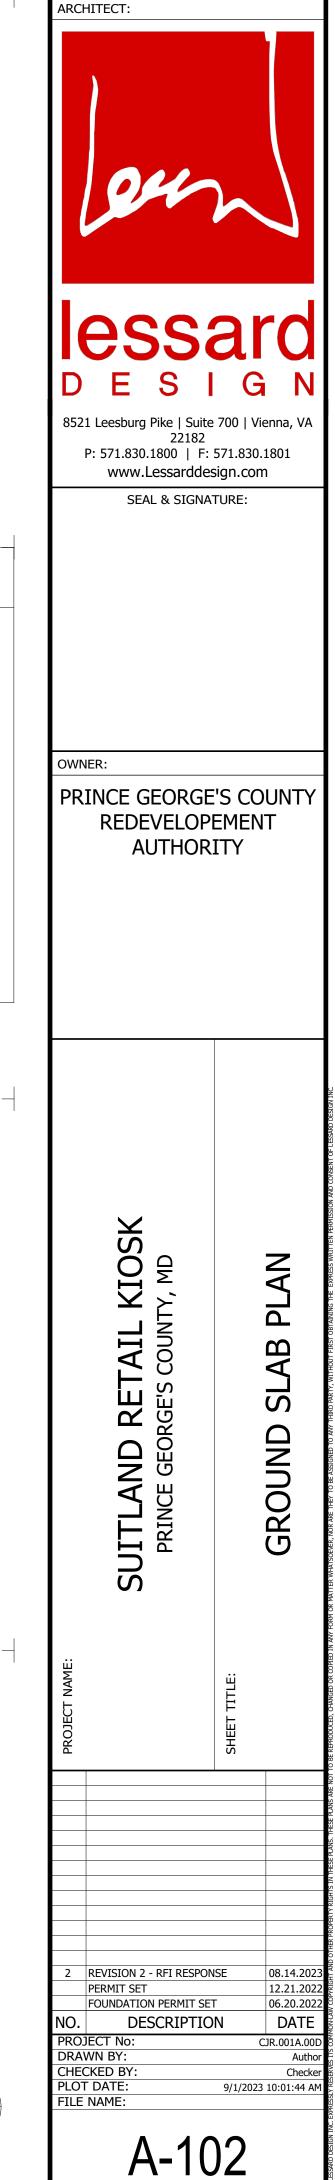

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1 A-312 D Ē 8 DOWN LIGHT AT BUILDING PERIMETER; REFER TO ELEVATIONS


15' - 3" • A.F.F.

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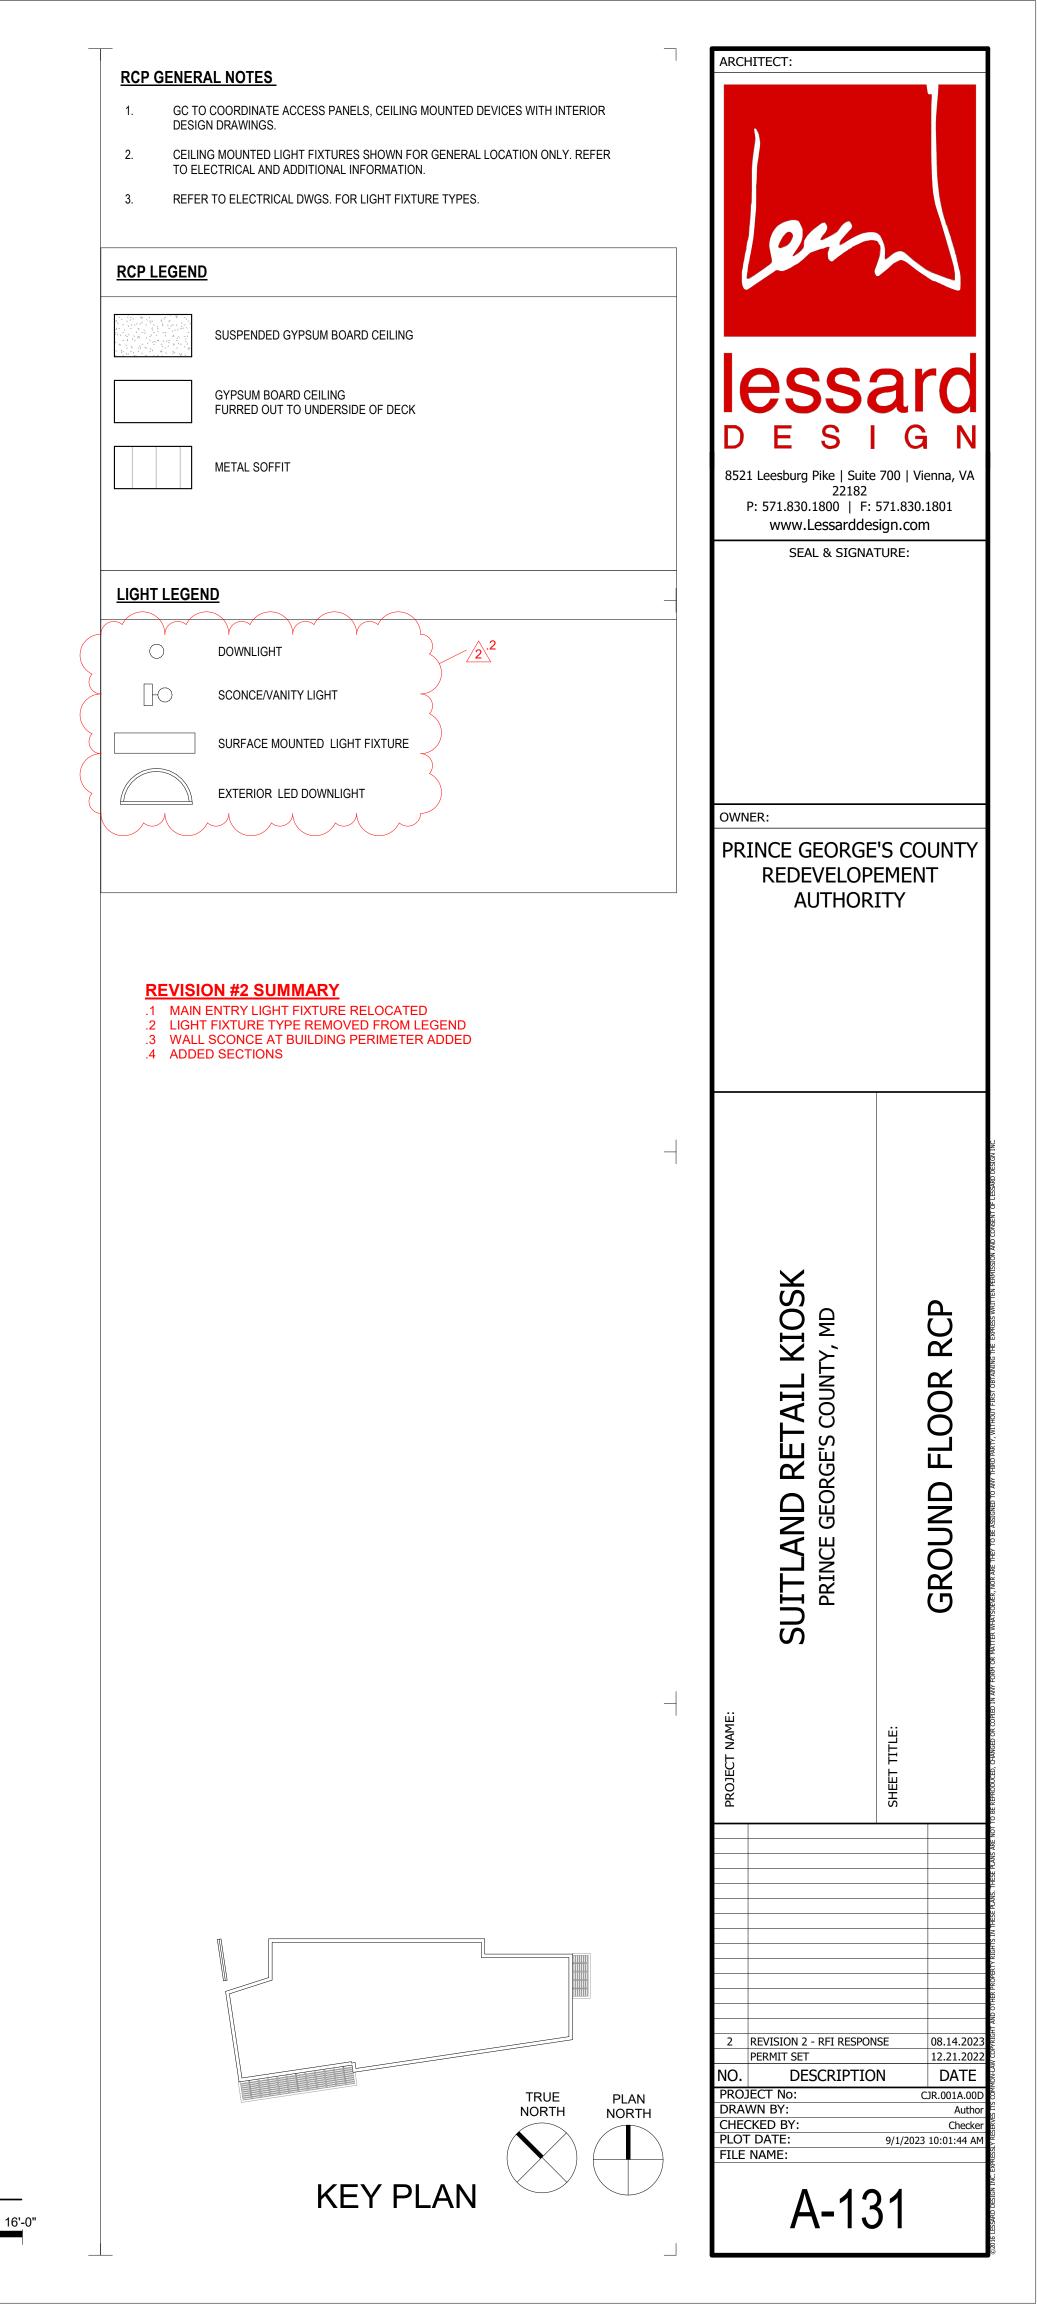
**MECH.** 101 _____ 2 A-313


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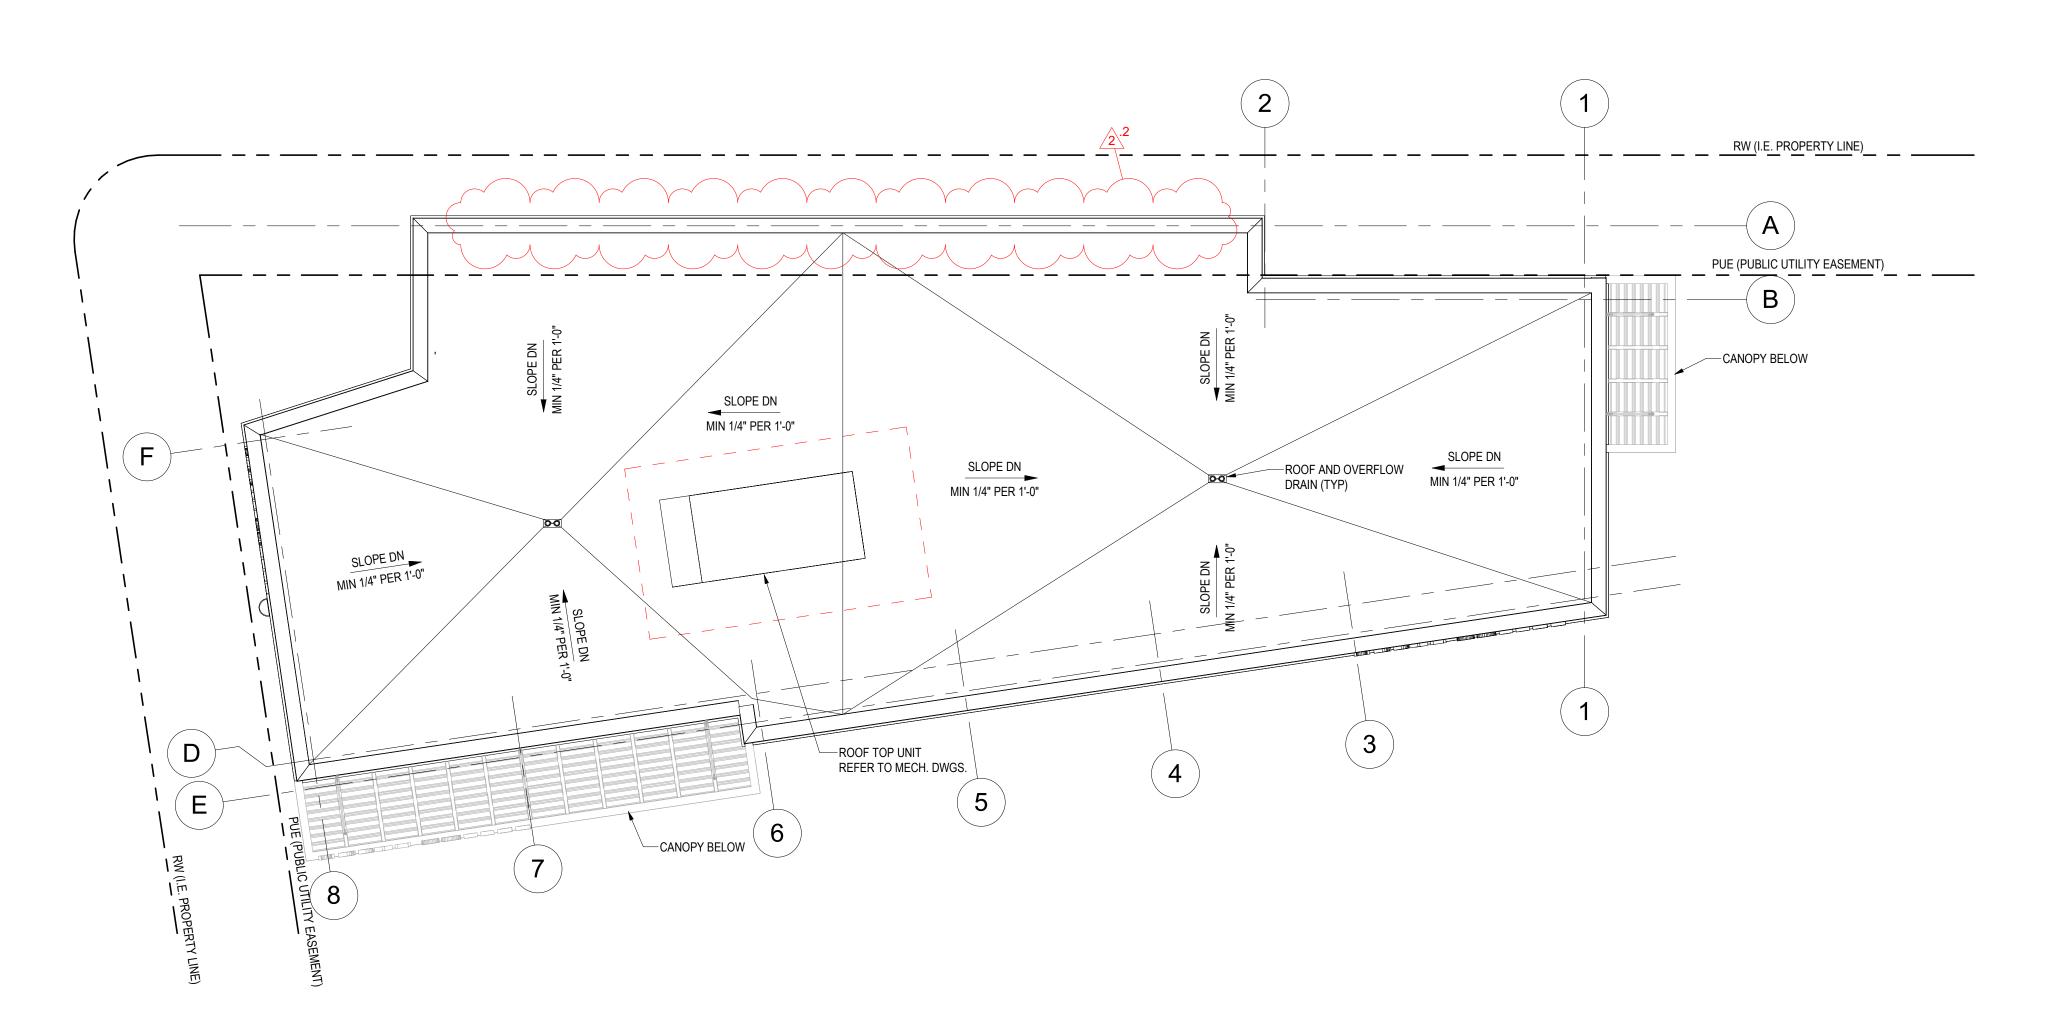


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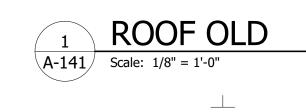




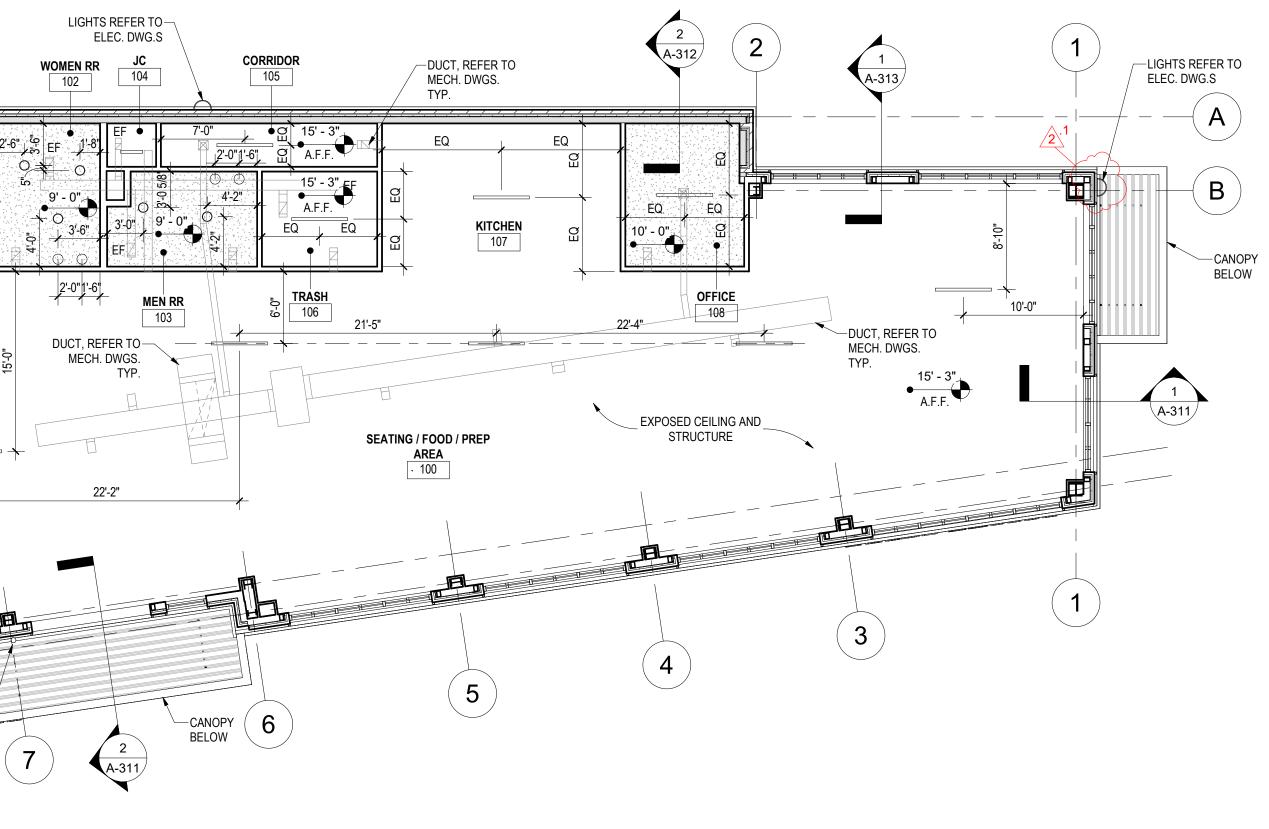




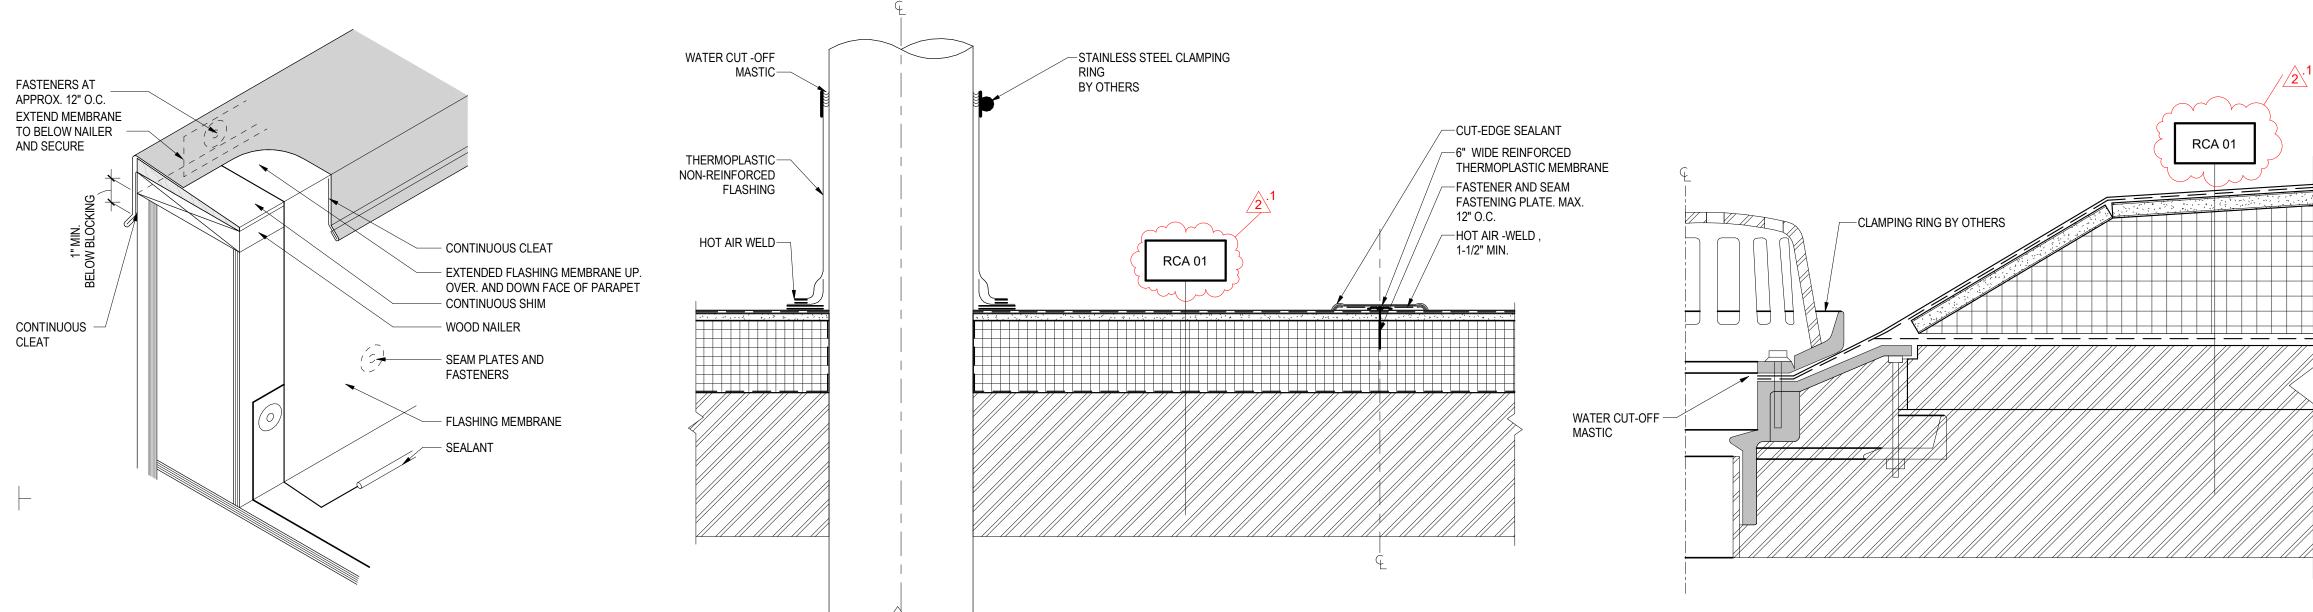





### <u>ROOF l</u>


ROOF LEG	<u>SEND</u>	ARC	CHITECT:	
	ROOF DRAIN - OVERFLOW DRAIN EXHAUST VENT ROOF TOP UNIT (REFER TO MECHANICAL UNIT) FIRE ALARM (REFER TO MECHANICAL DWGS.) RECEPTACLES (REFER TO ELECTRICAL DWGS.)		lee	
.1 R	ISION #2 SUMMARY OOF ASSEMBLY TYPE ASSIGNED ON ROOF DRAIN DETAILS VERFLOW SCUPPER AND SCUPPER DETAILS REMOVED	D	ES ES 21 Leesburg Pike   Suita 22182 P: 571.830.1800   F: www.Lessardde SEAL & SIGNA	G N e 700   Vienna, VA 571.830.1801 esign.com
			NER: RINCE GEORGE REDEVELOP AUTHOR	PEMENT
			SUITLAND RETAIL KIOSK PRINCE GEORGE'S COUNTY, MD	ROOF PLAN AND DETAILS
		PROJECT NAME:		SHEET TITLE:
			DJECT No: AWN BY: ECKED BY:	12.21.2022 DN DATE CJR.001A.00E Authou Checker
	KEY PLAN		IT DATE: E NAME: A-14	8/17/2023 2:45:21 PM

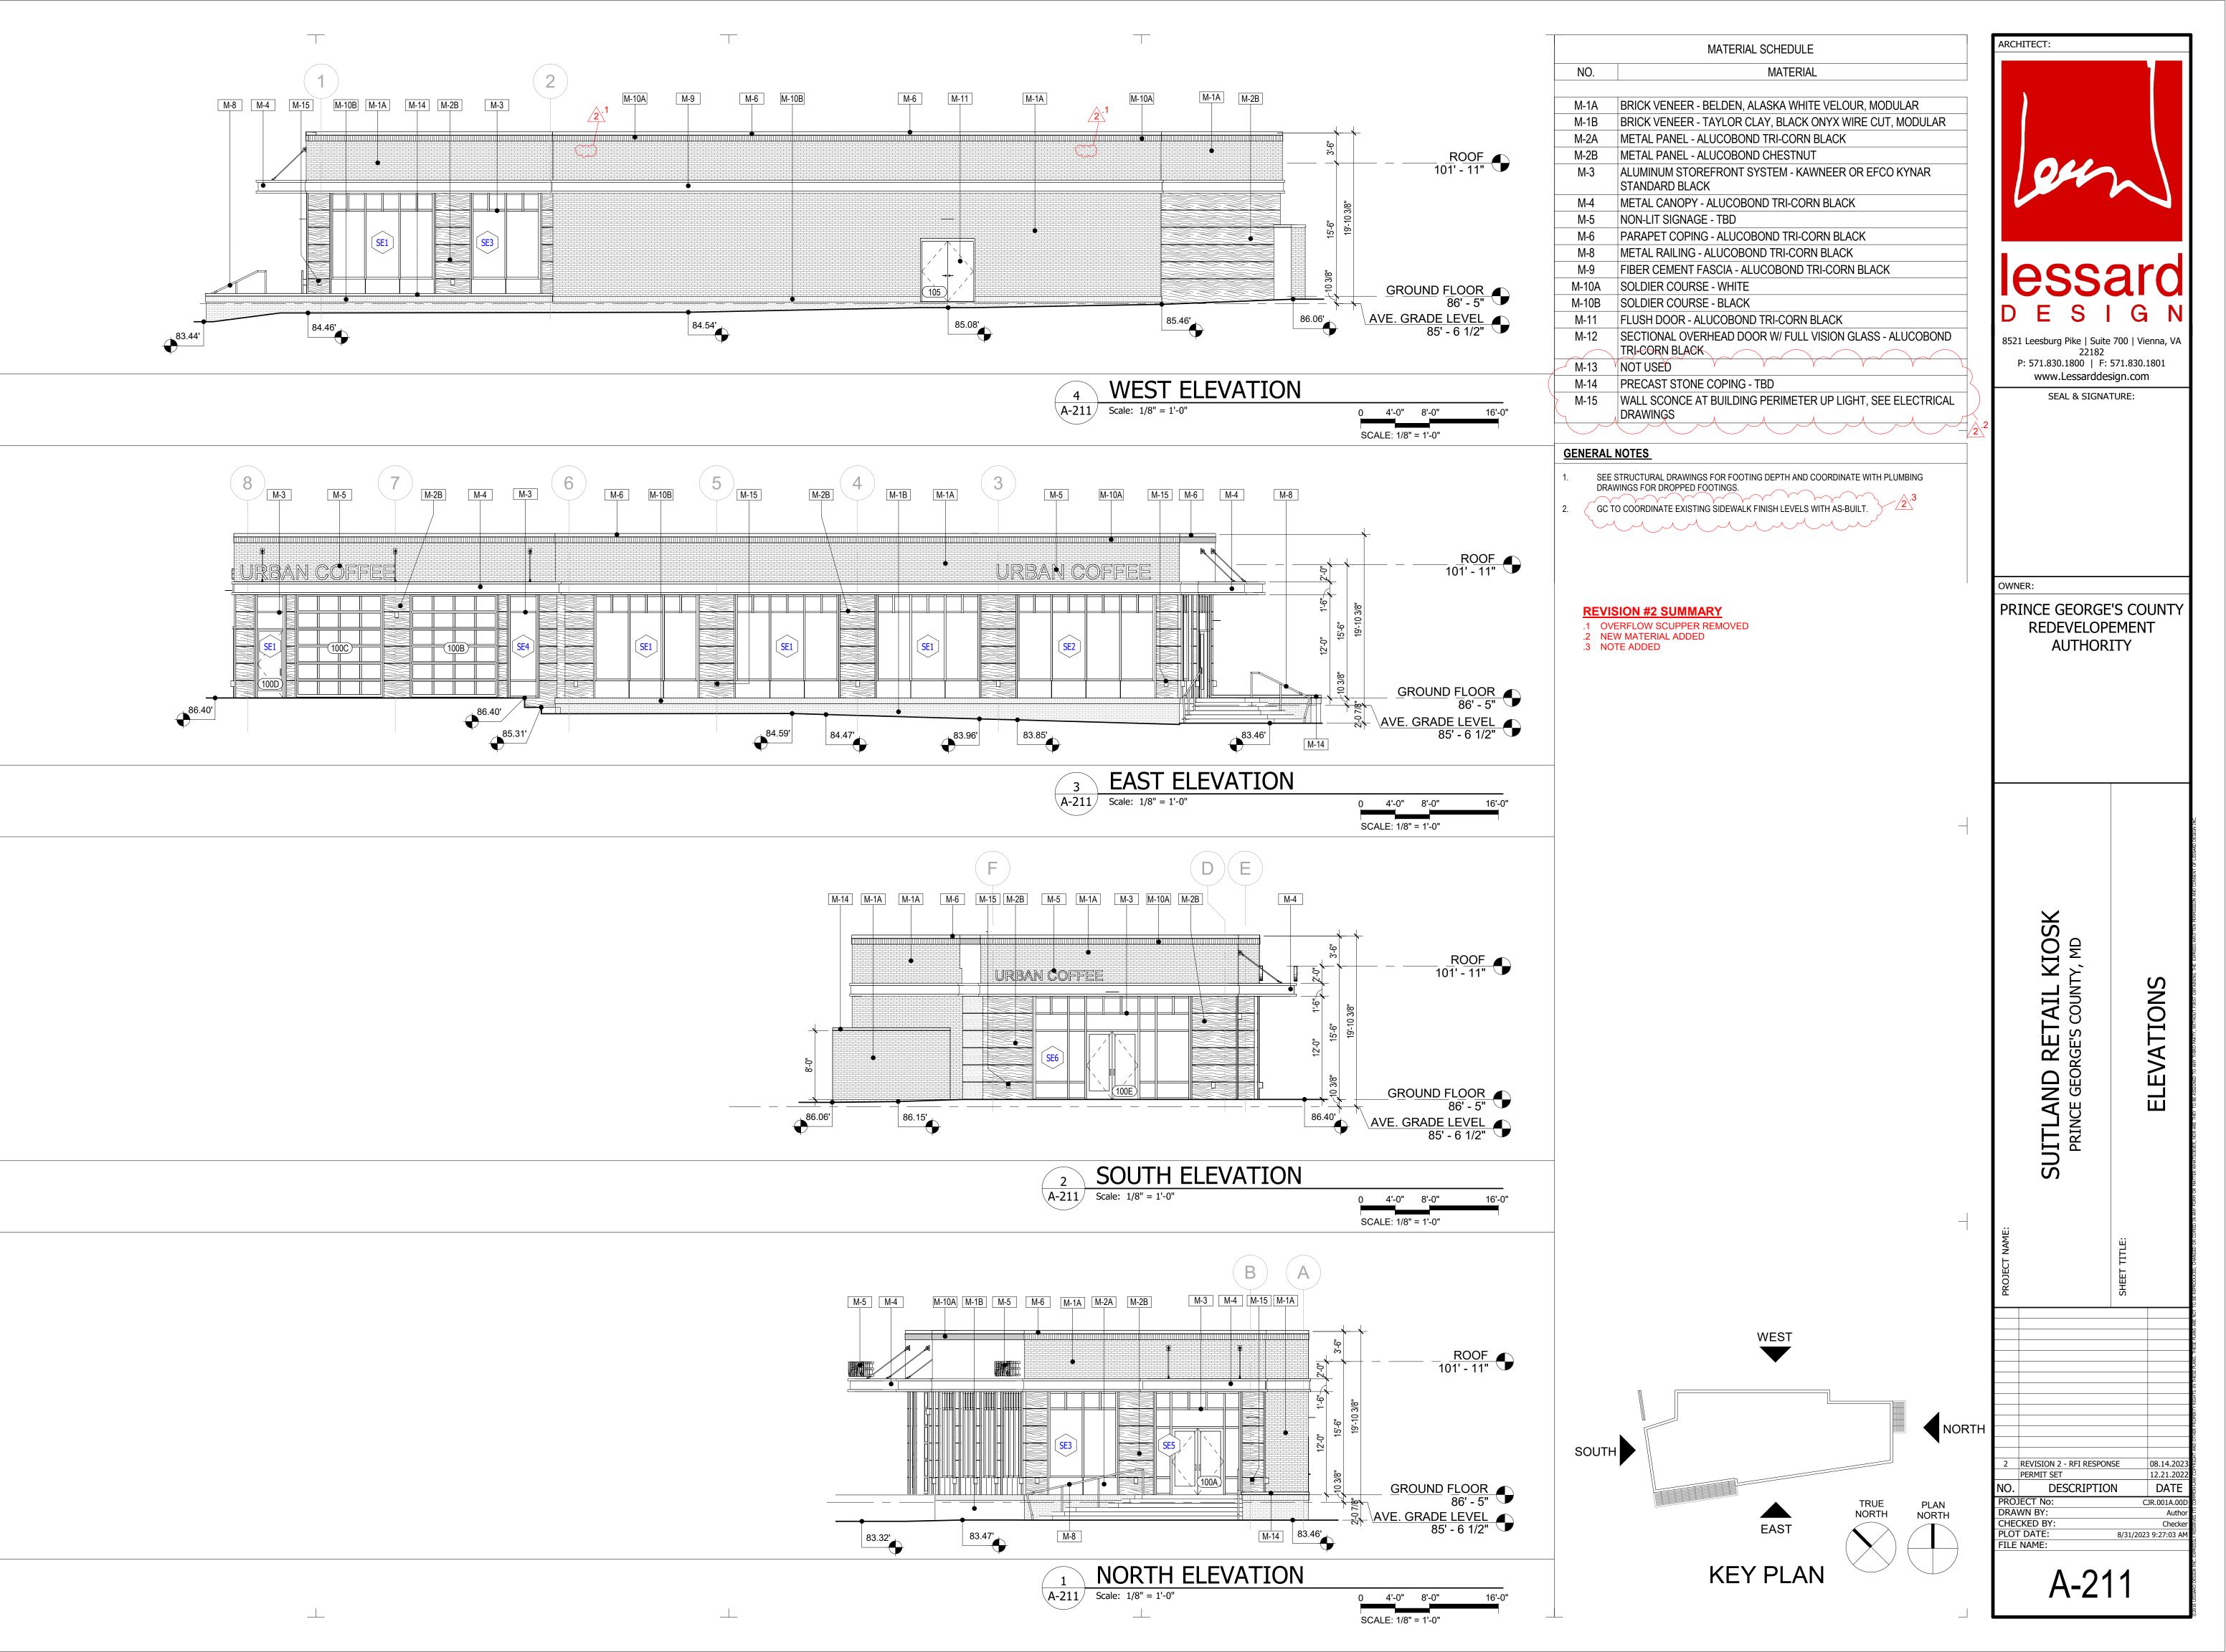



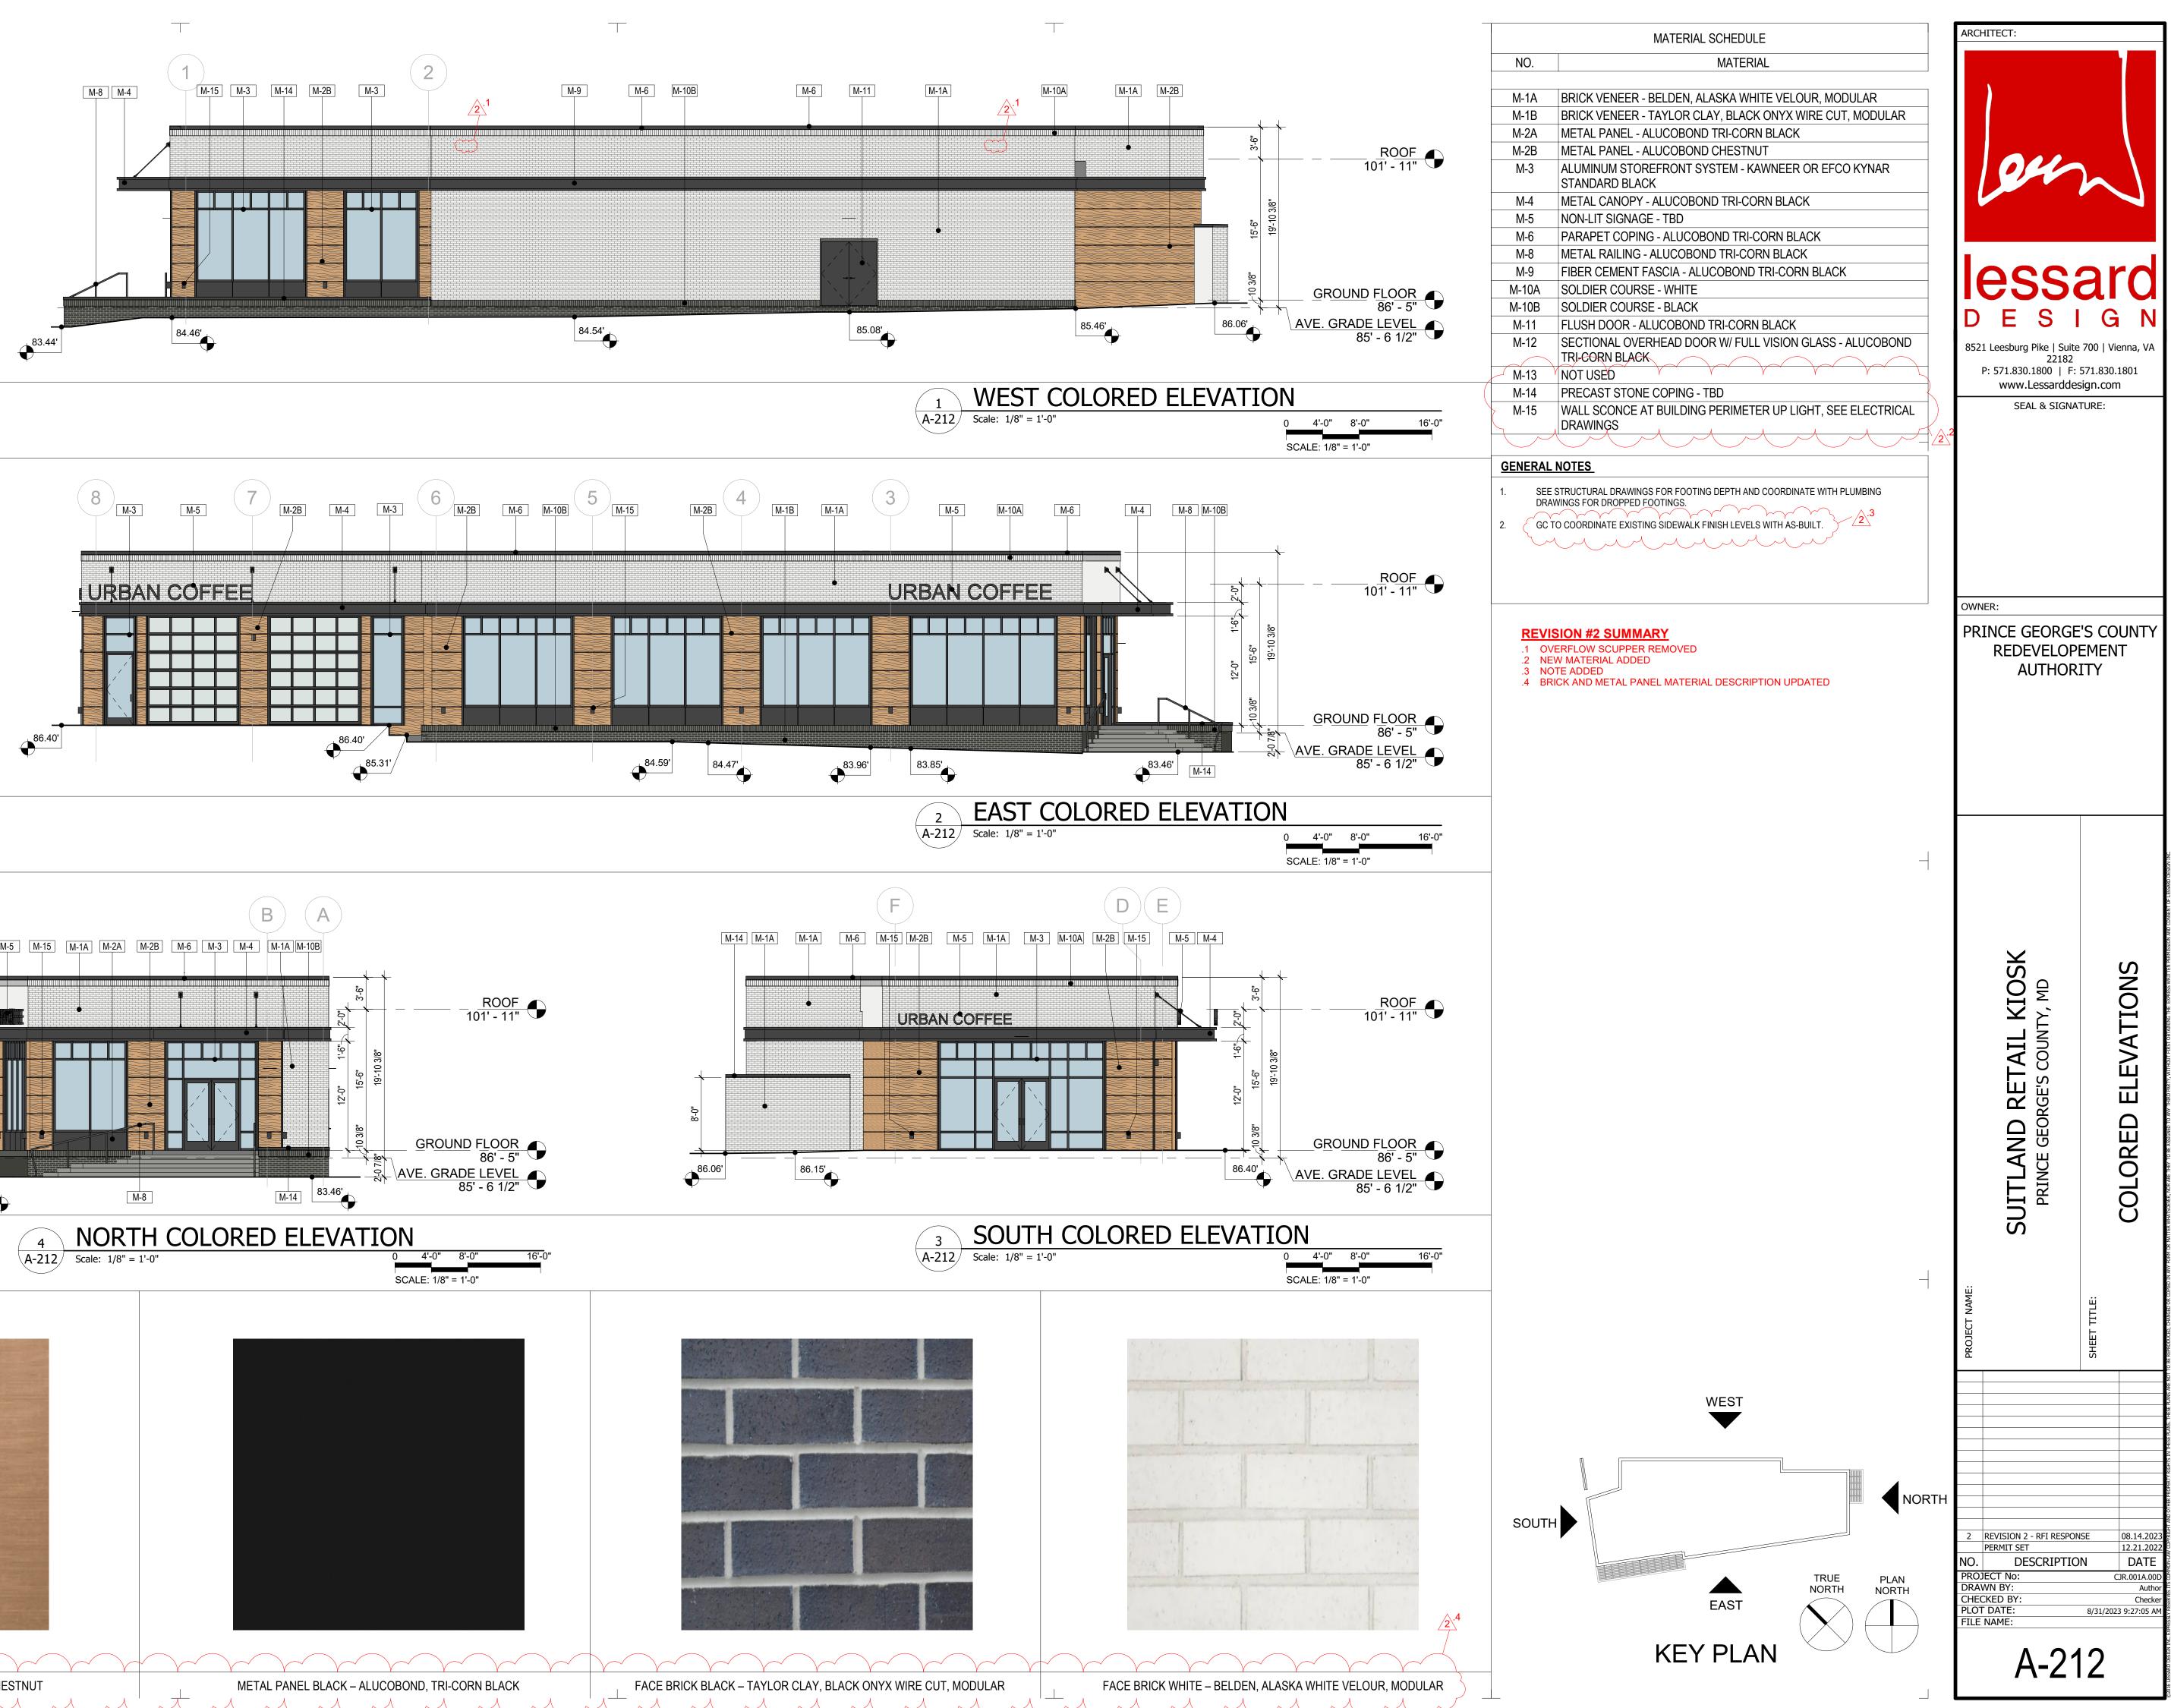

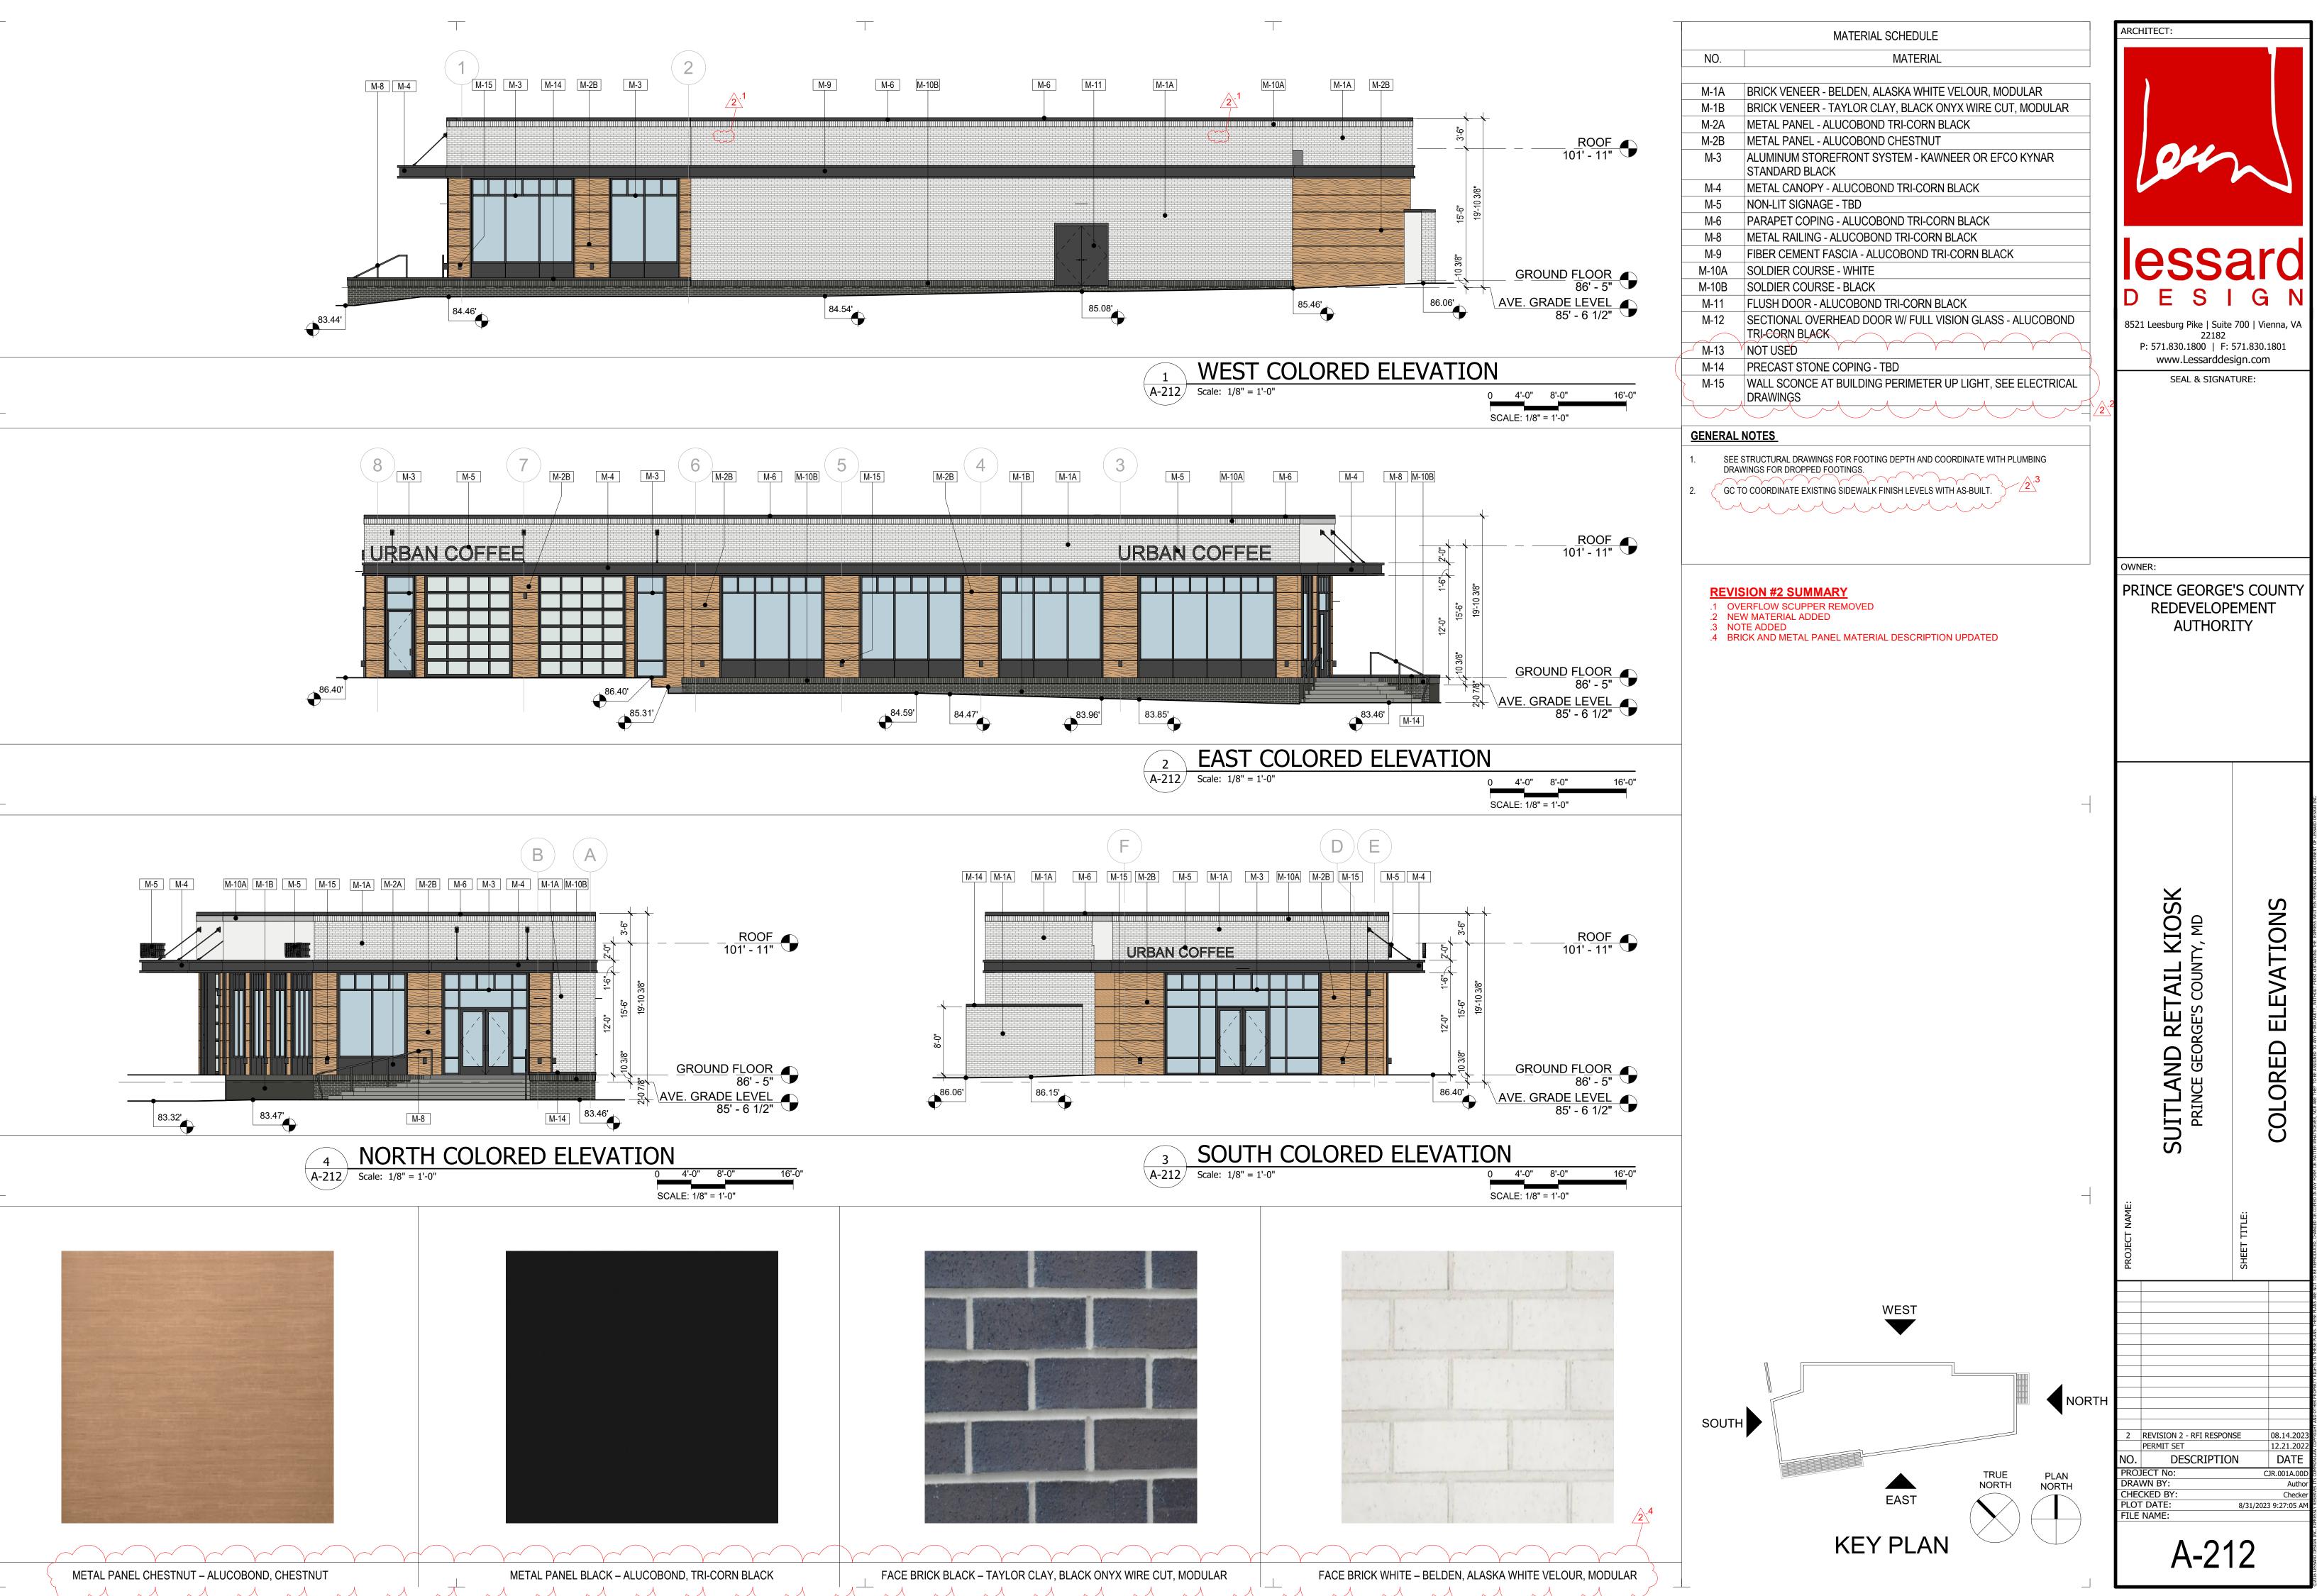

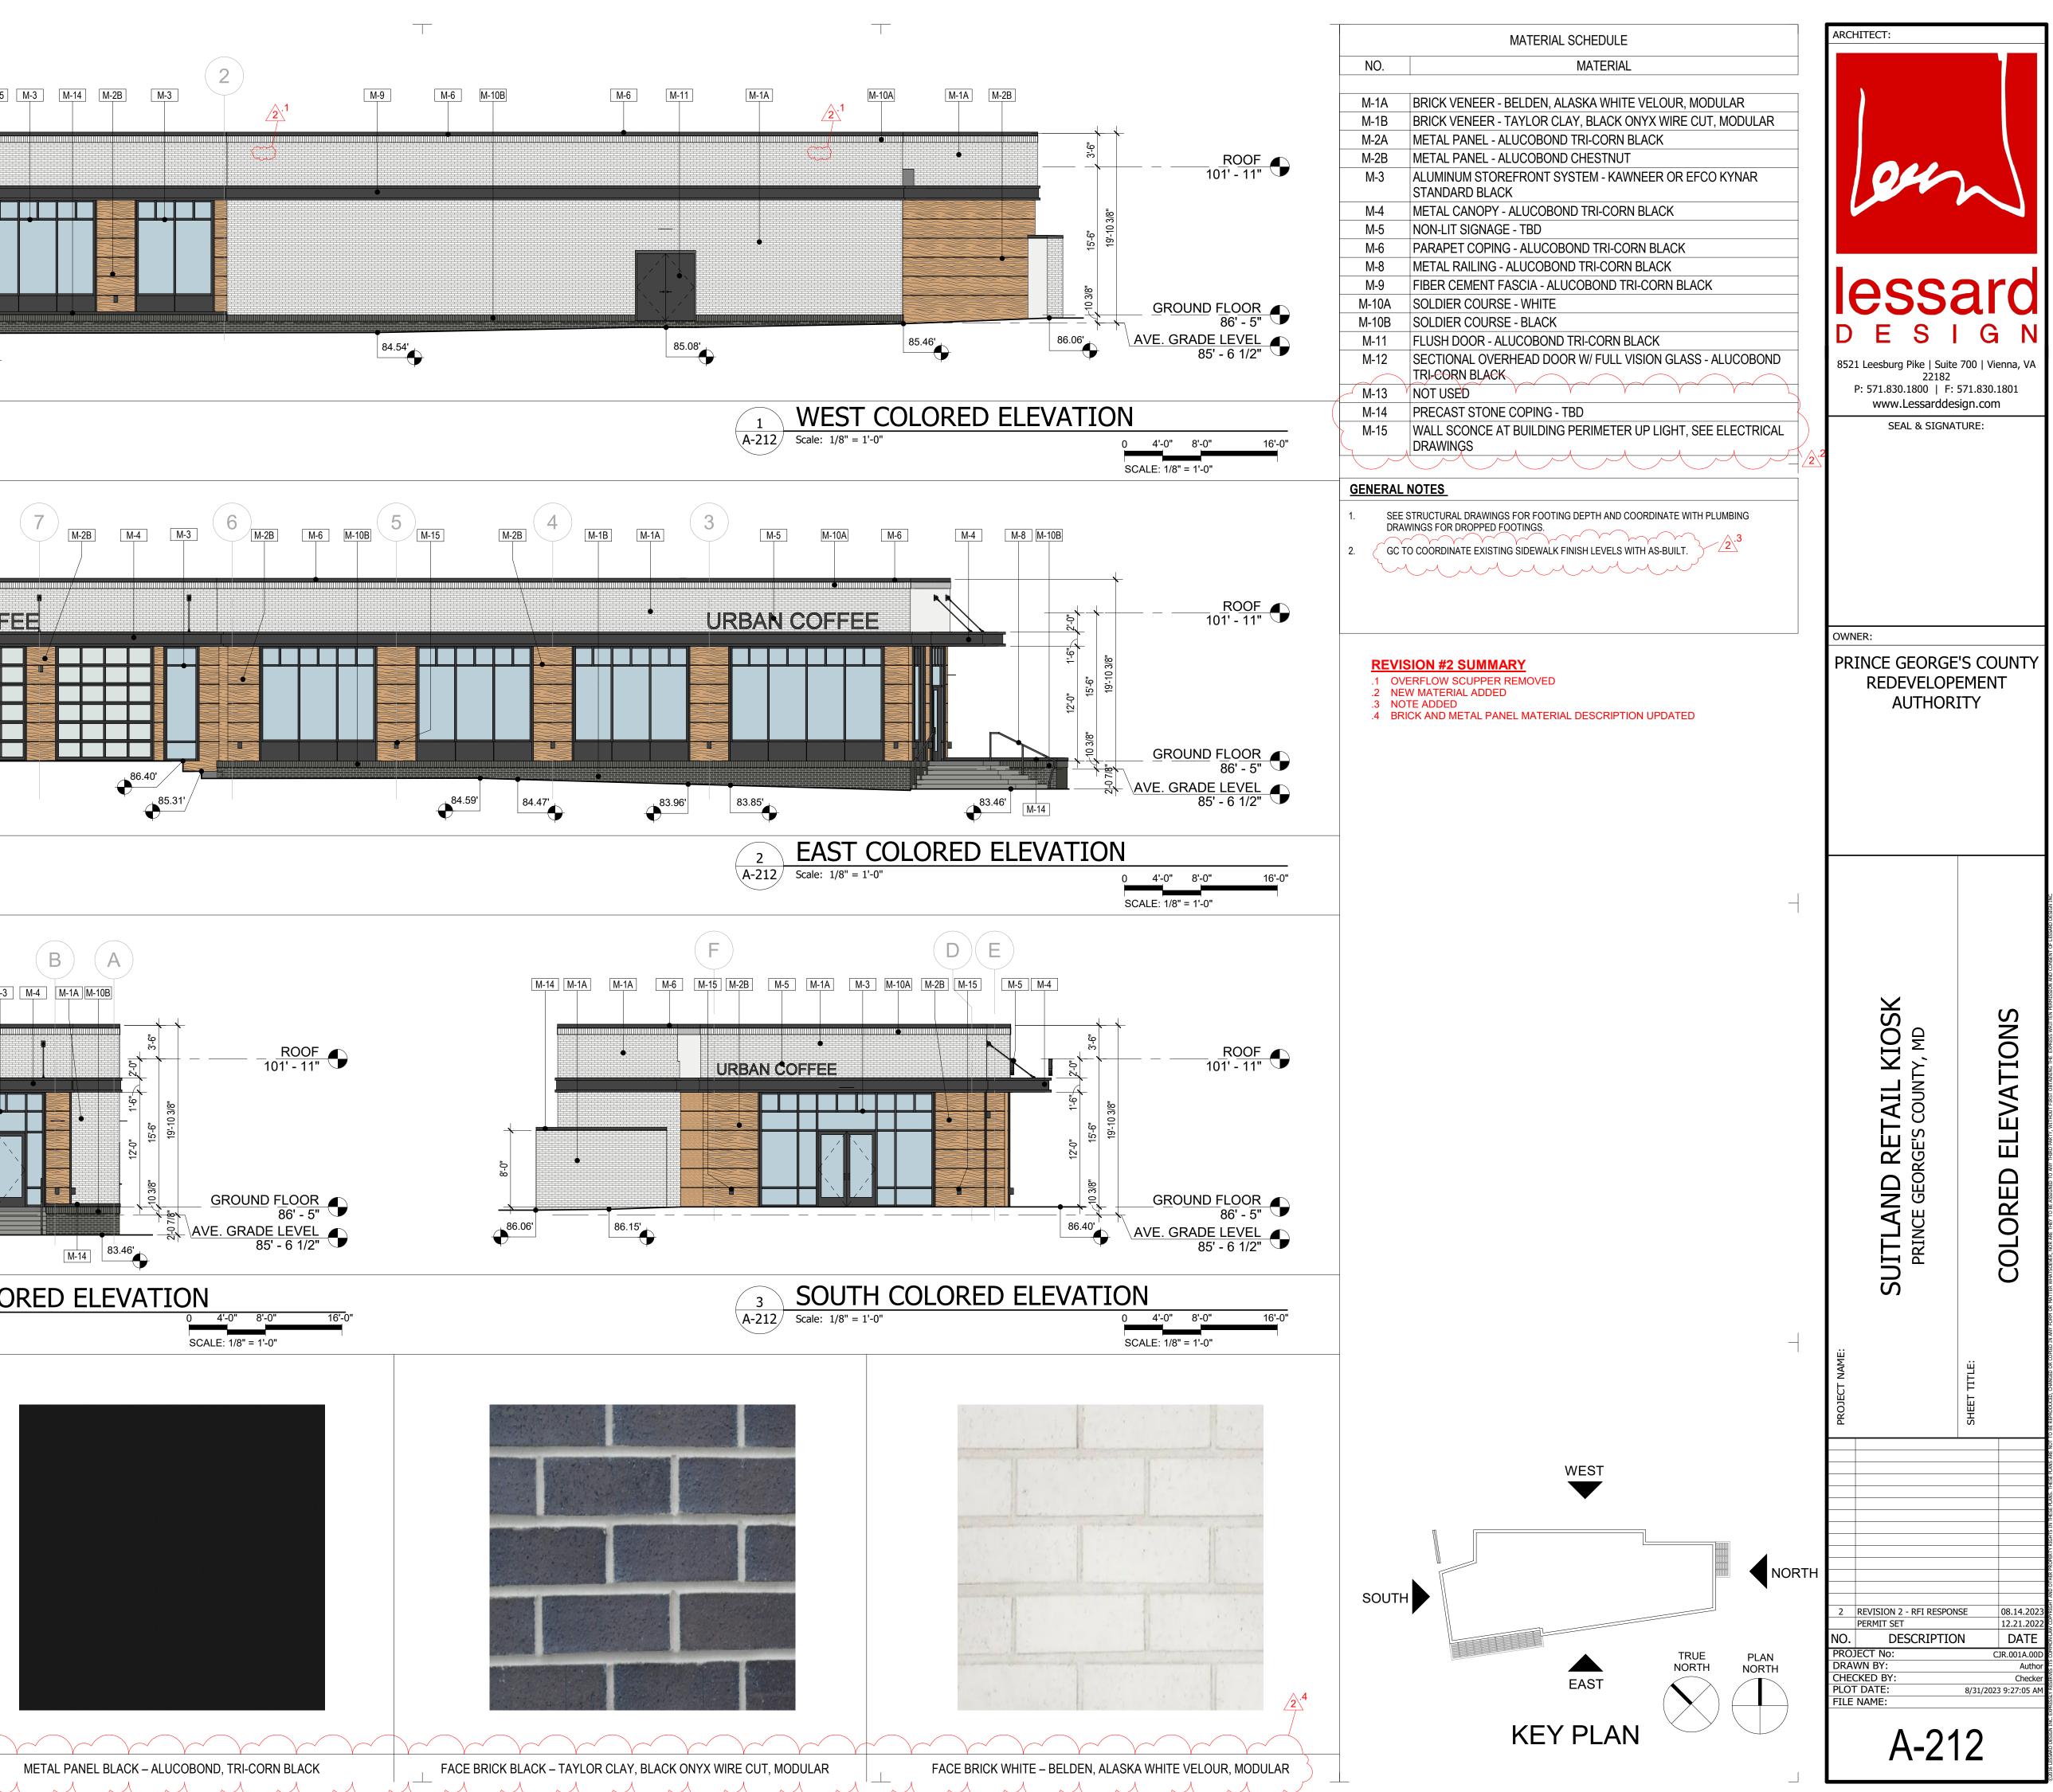













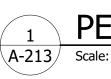


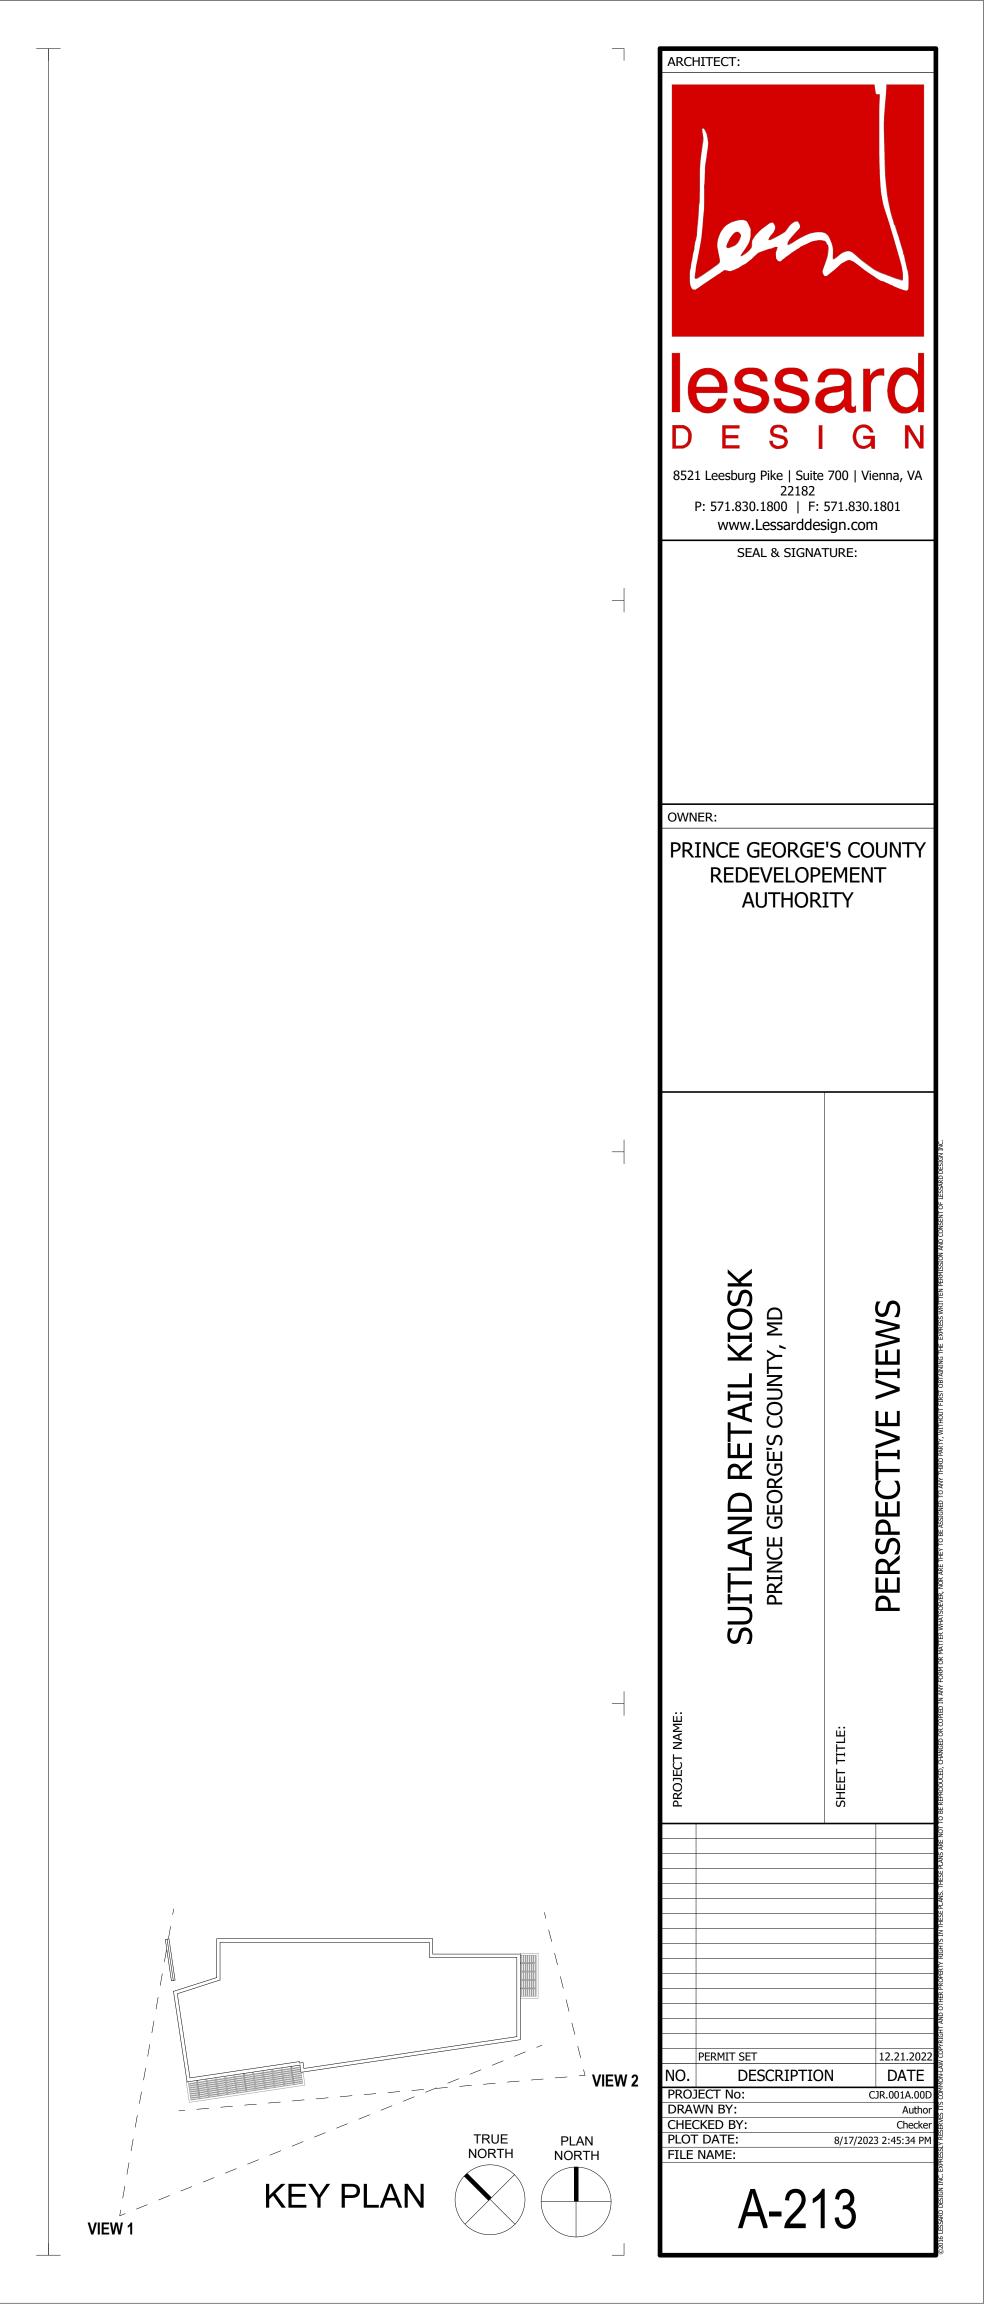

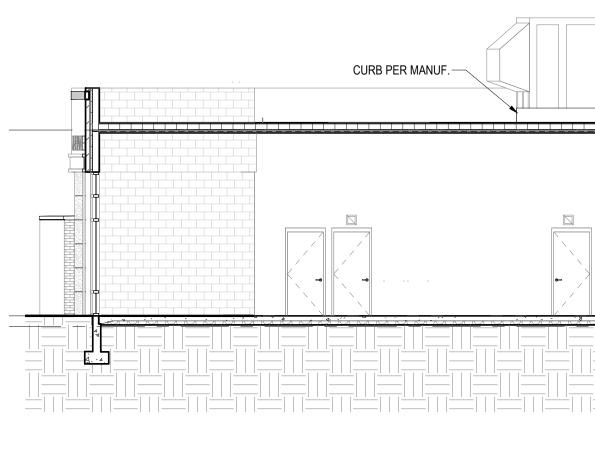

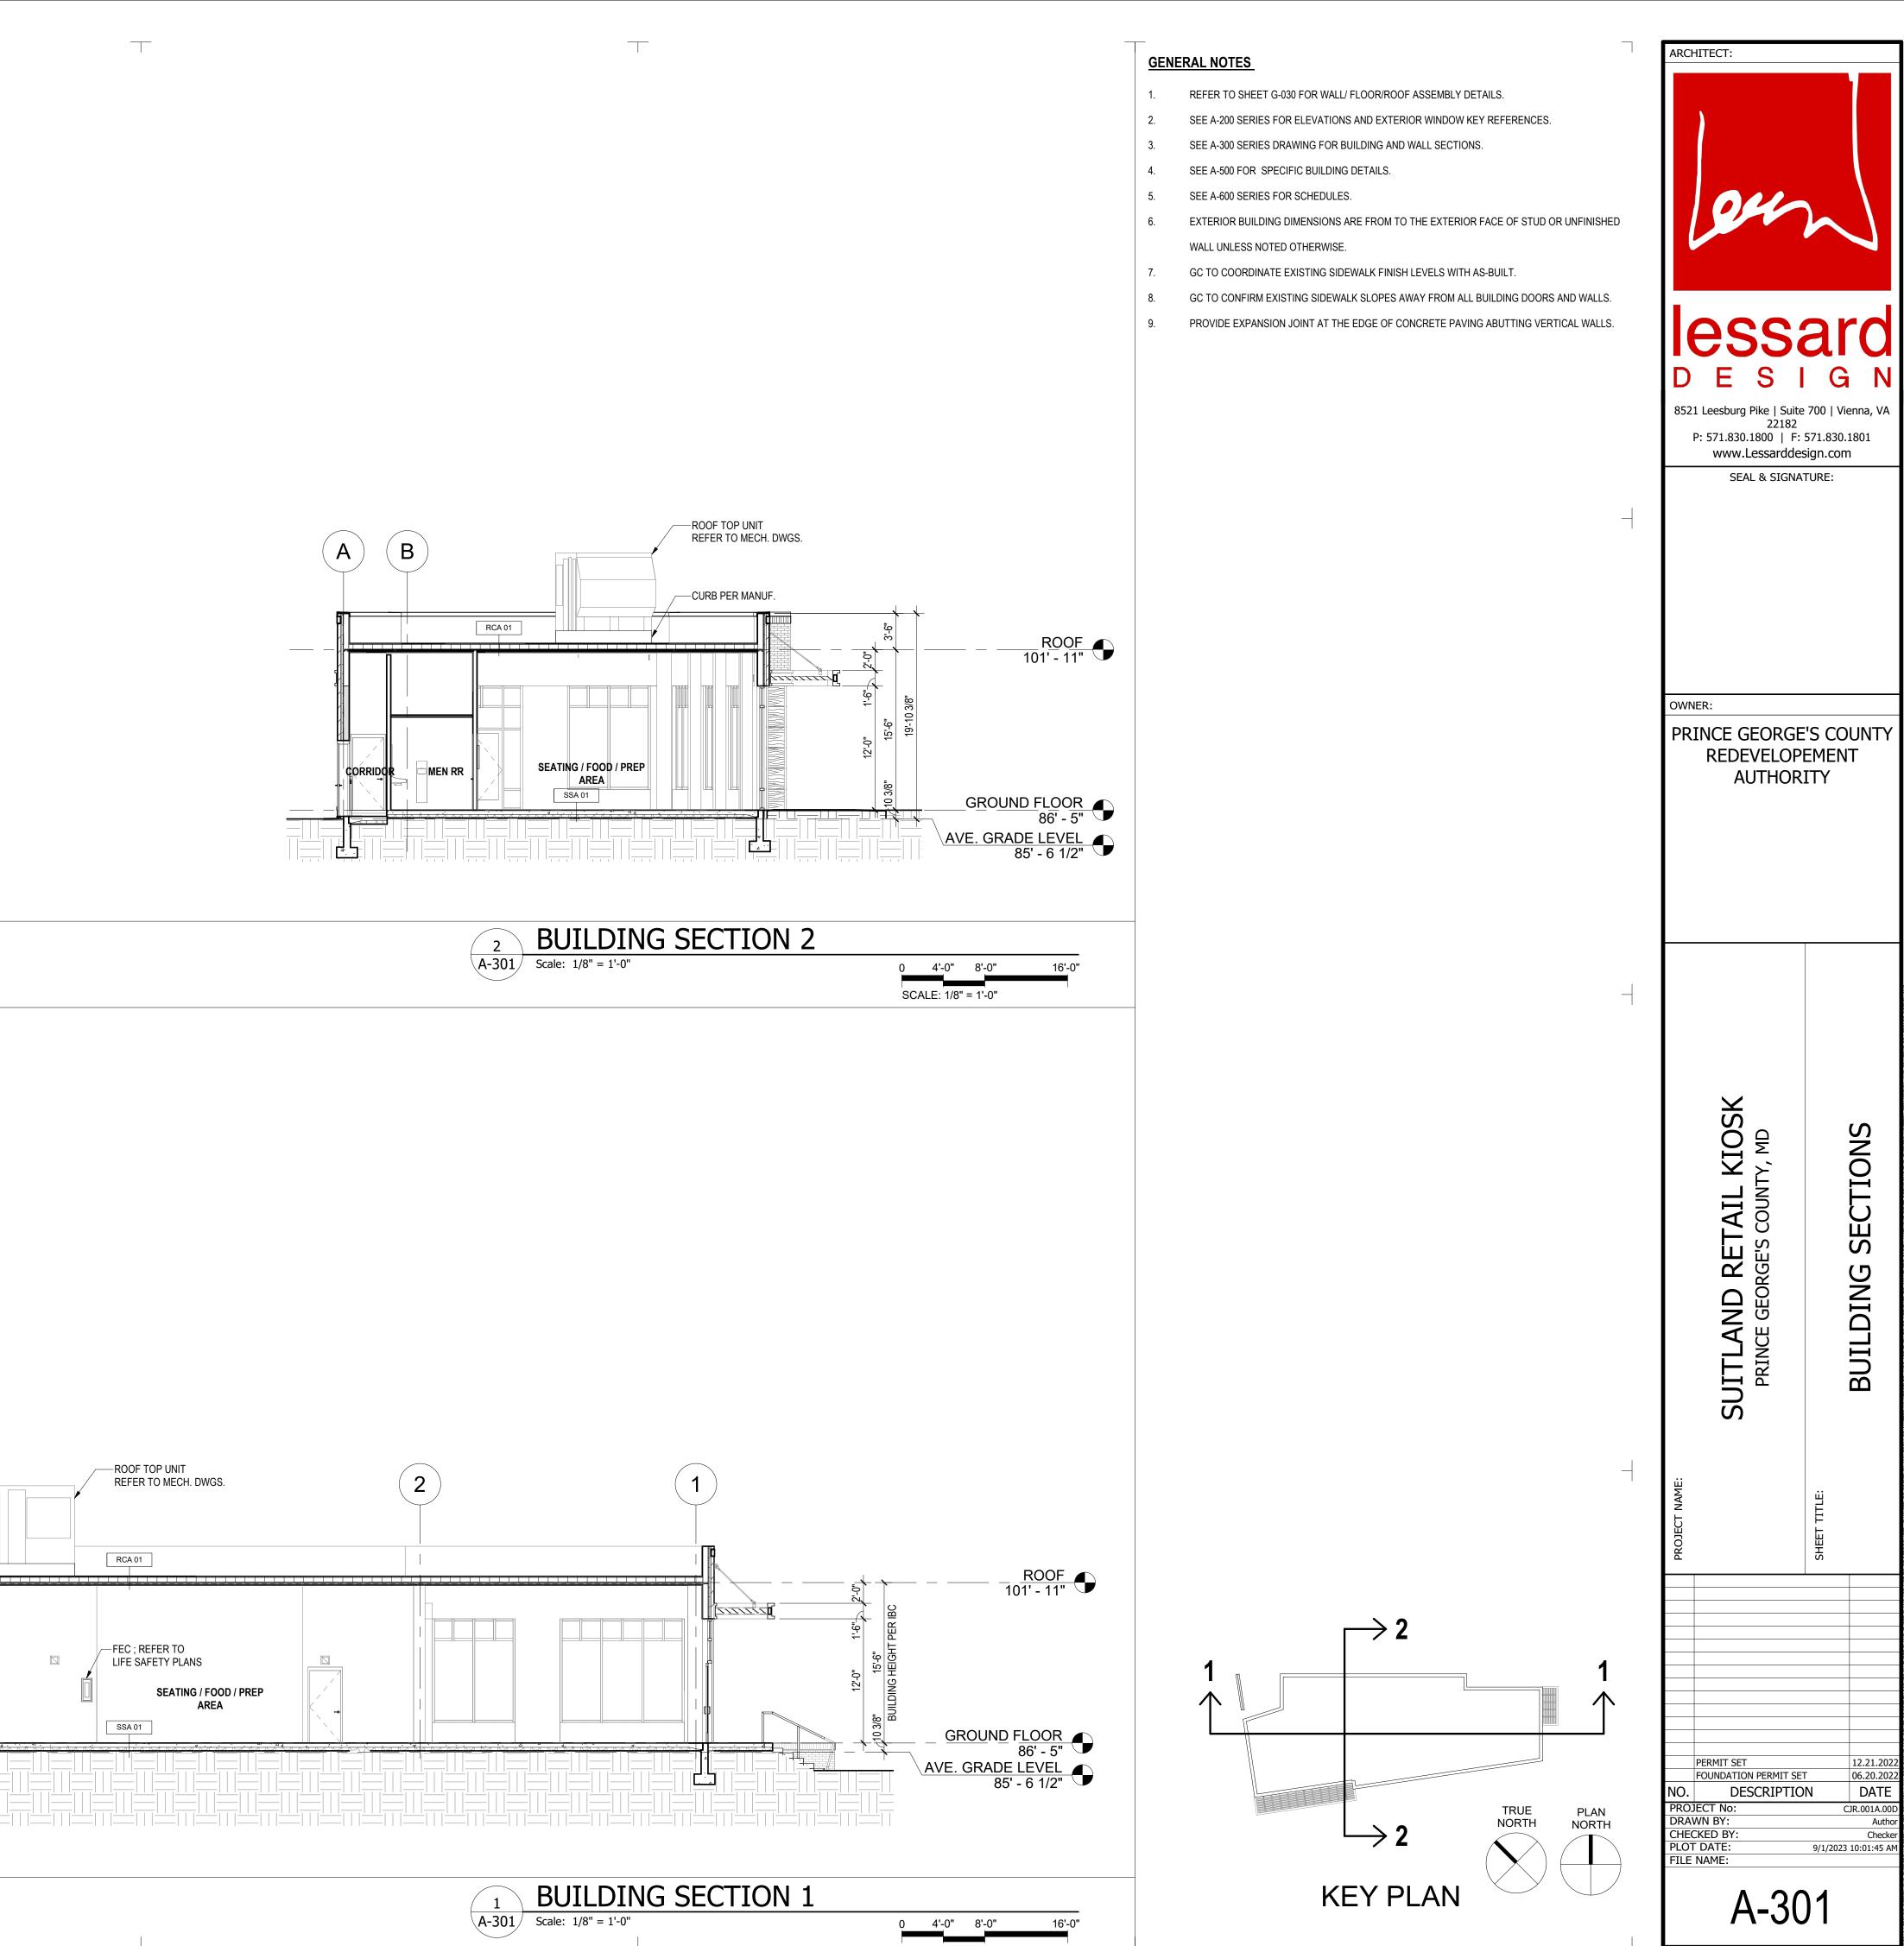



16'-0"

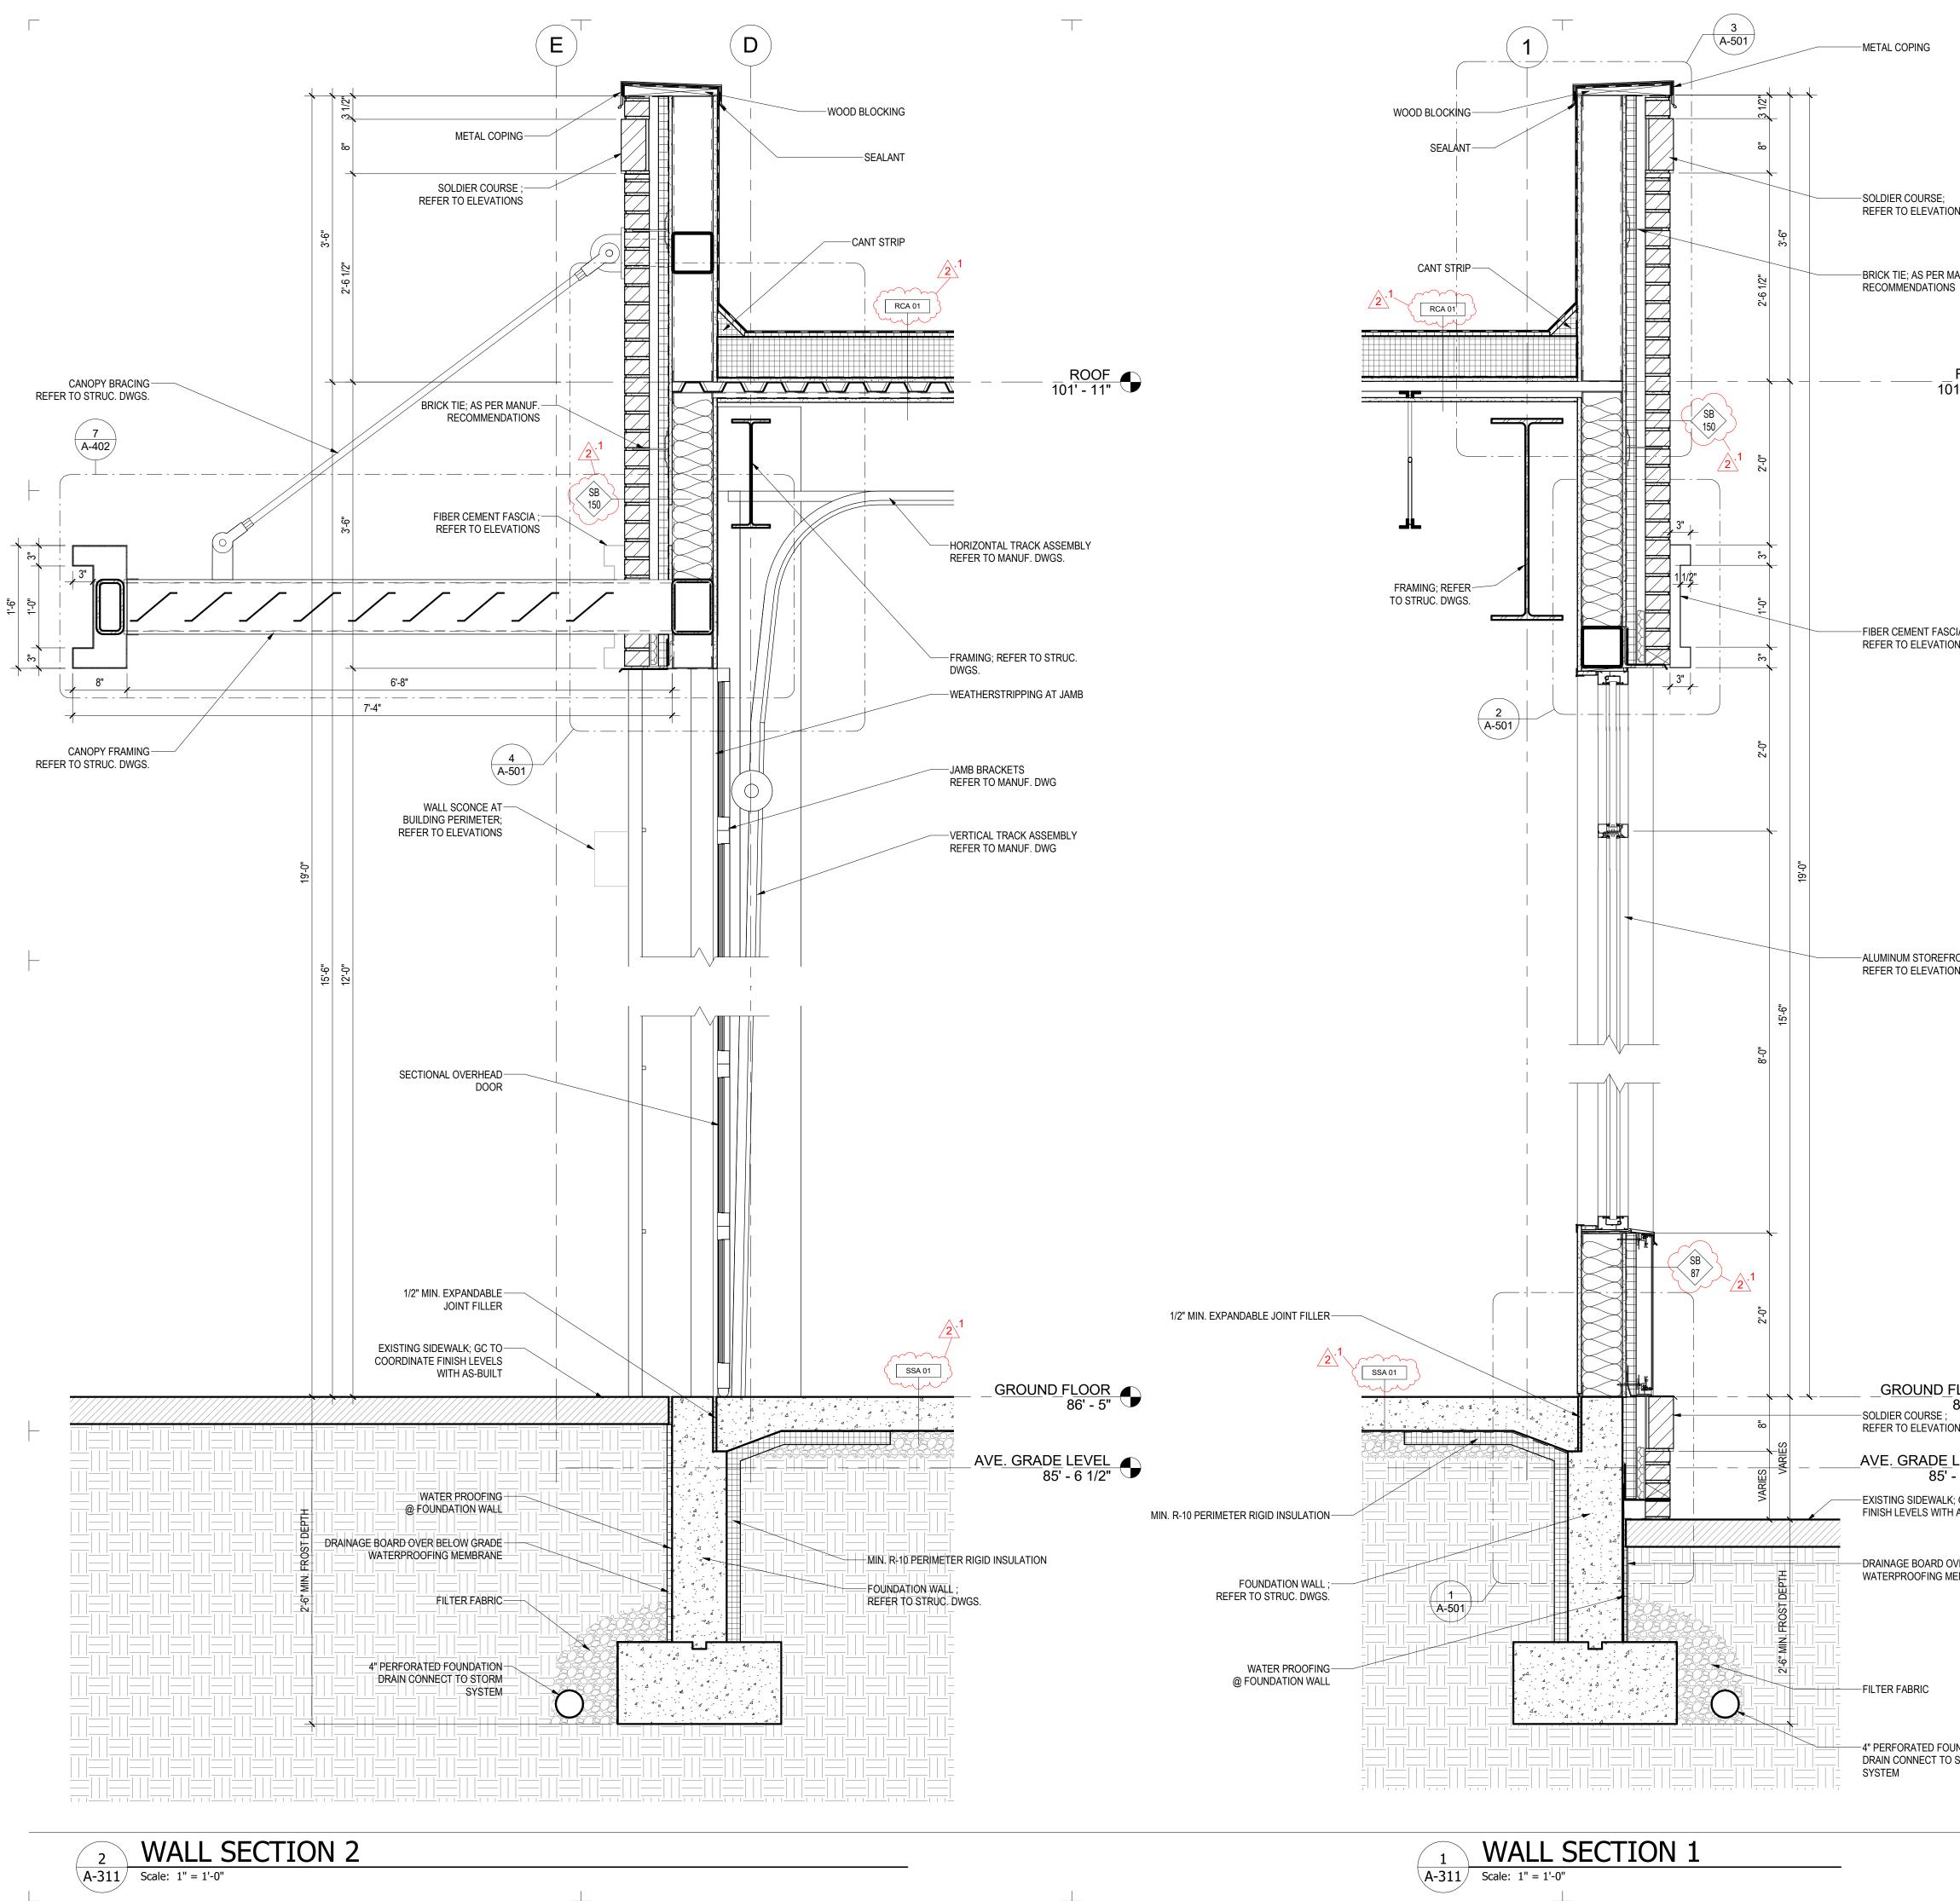

	WALL SECTION	,
A-311	Scale: 1" = 1'-0"	


	GENERAL NOTES	ARCHITECT:	
	1. REFER TO SHEET G-030 FOR WALL/ FLOOR/ROOF ASSEMBLY DETAILS.		
	2.       SEE A-200 SERIES FOR ELEVATIONS AND EXTERIOR WINDOW KEY REFERENCES.         3.       SEE A-300 SERIES DRAWING FOR BUILDING AND WALL SECTIONS.		
	<ul> <li>4. SEE A-500 FOR SPECIFIC BUILDING DETAILS.</li> <li>5. SEE A-600 SERIES FOR SCHEDULES.</li> </ul>		
DNS	6. EXTERIOR BUILDING DIMENSIONS ARE FROM TO THE EXTERIOR FACE OF STUD OR UNFINISHED		$\sim$
	WALL UNLESS NOTED OTHERWISE.         7.       GC TO COORDINATE EXISTING SIDEWALK FINISH LEVELS WITH AS-BUILT.		
IANUF. S	<ol> <li>8. GC TO CONFIRM EXISTING SIDEWALK SLOPES AWAY FROM ALL BUILDING DOORS AND WALLS.</li> <li>9. PROVIDE EXPANSION JOINT AT THE EDGE OF CONCRETE PAVING ABUTTING VERTICAL WALLS.</li> </ol>	less	ard
R <u>OOF</u> 1' - 11"	REVISION #2 SUMMARY .1 WALL/FLOOR/ROOF ASSEMBLY TYPES INDICATED .2 NOTES ADDED	DES21 Leesburg Pike   Suite 22182	G N 2 700   Vienna, VA
		P: 571.830.1800   F: www.Lessardde SEAL & SIGNA	sign.com
CIA ; NNS		OWNER:	
		PRINCE GEORGE REDEVELOP	EMENT
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		ITLAND RETAIL KIO PRINCE GEORGE'S COUNTY, MD	NS
		TAIL 5 COUN	WALL SECTIONS
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		SUITLAND RETAIL KIOSK PRINCE GEORGE'S COUNTY, MD	Ň
FLOOR 86' - 5"	_		
L <u>EVEL</u> - 6 1/2" ①		PROJECT NAME:	TITLE:
; GC TO COORDINATE AS-BUILT		PROJEC	SHEET TITLE:
VER BELOW GRADE EMBRANE			
	$\leftarrow$	2 REVISION 2 - RFI RESPON PERMIT SET	ISE 08.14.2023 12.21.2022
UNDATION STORM	TRUE PLAN NORTH NORTH	NO. DESCRIPTIC PROJECT No: DRAWN BY: CHECKED BY:	
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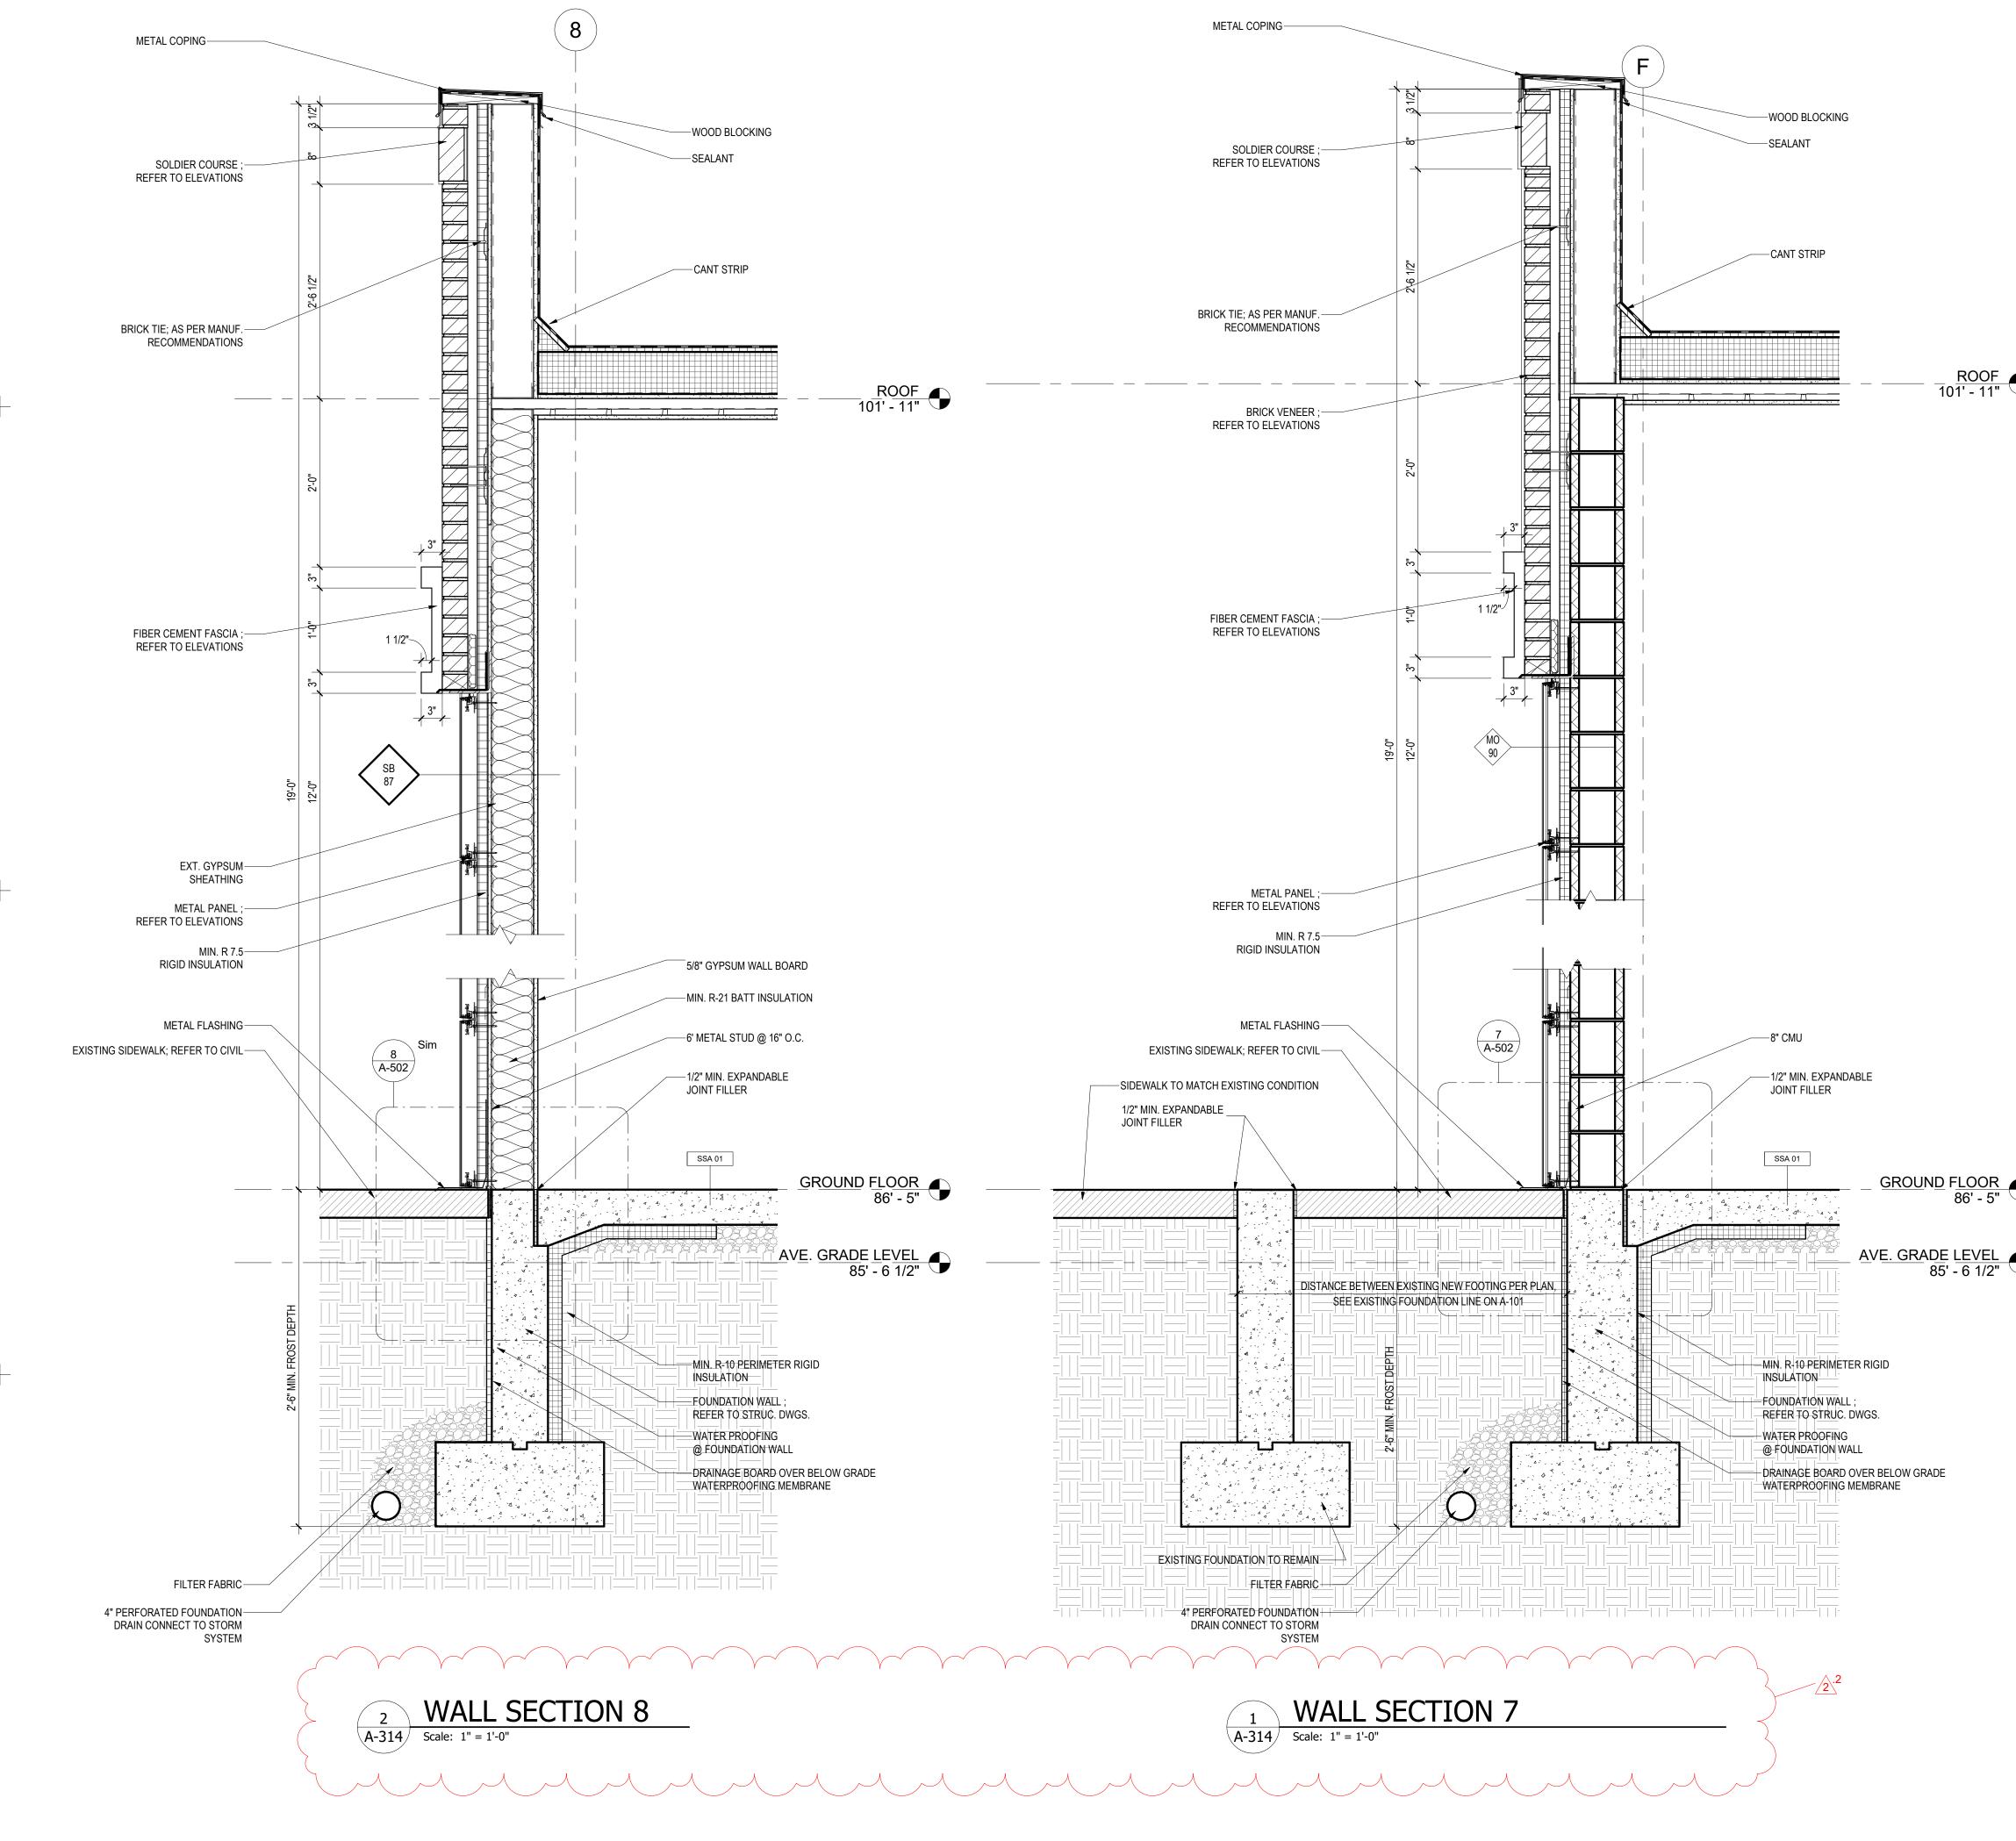


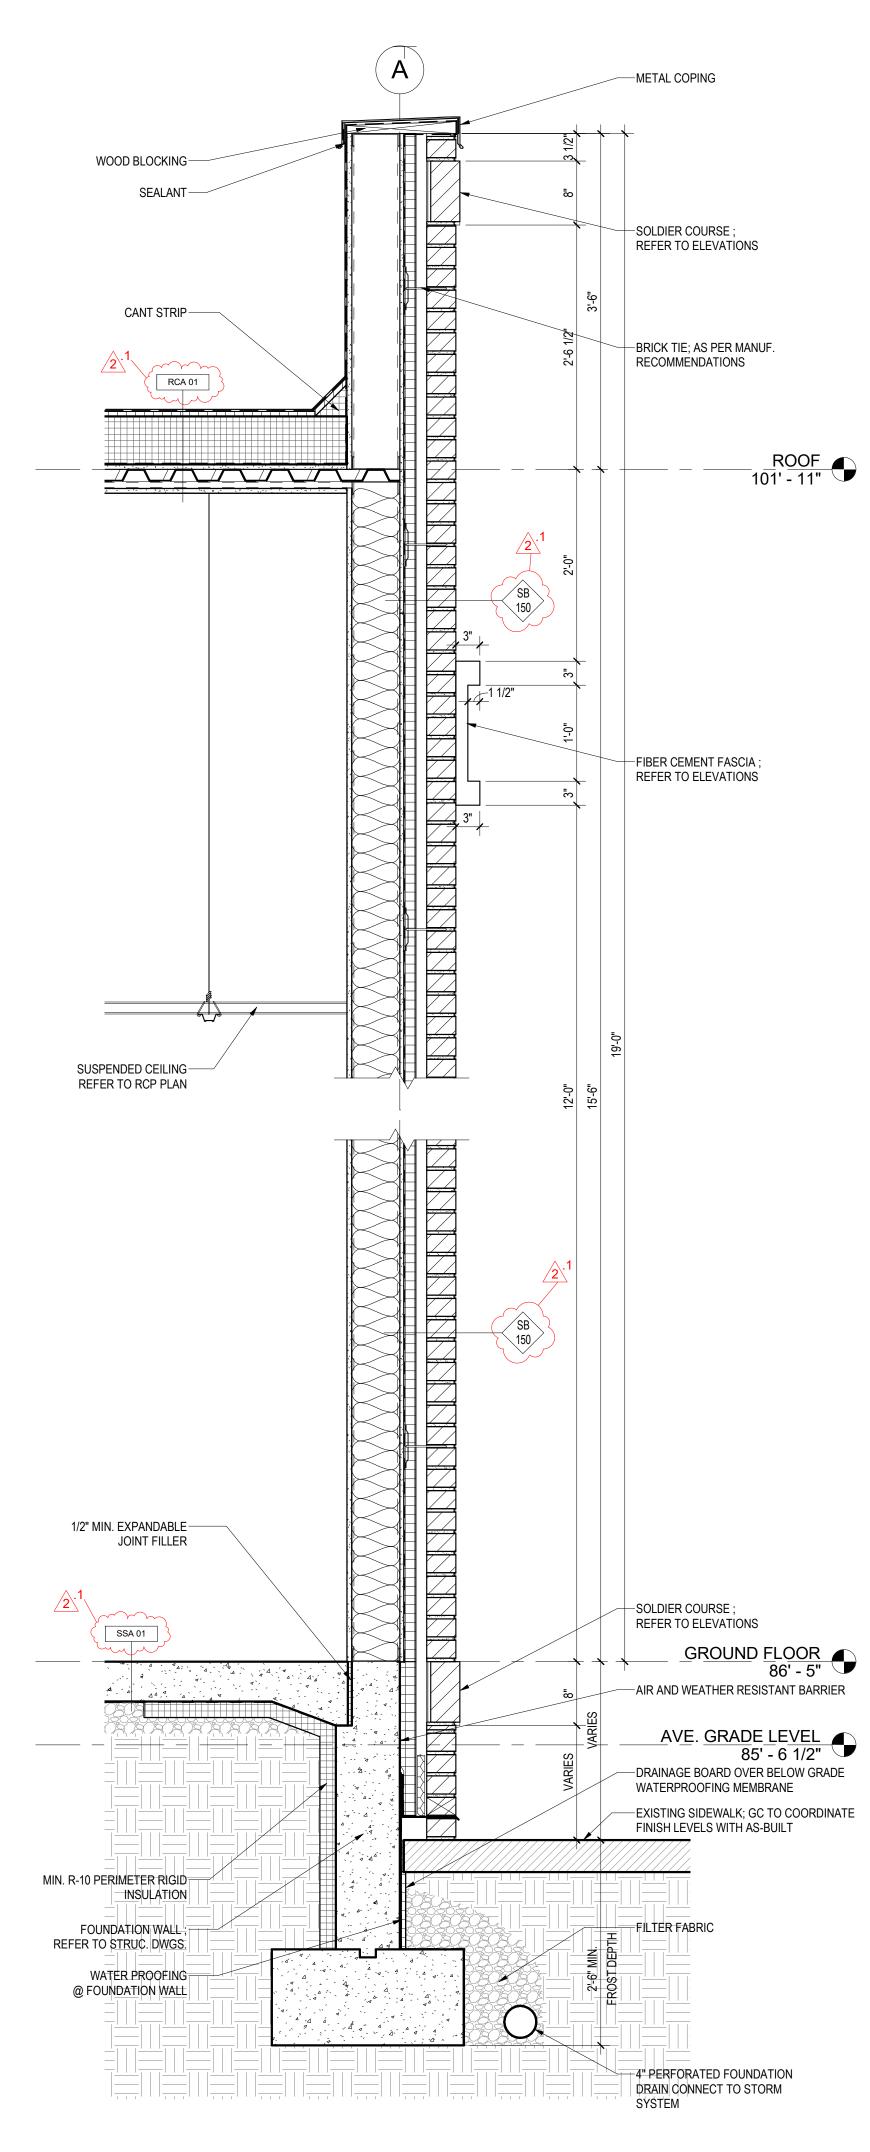1	WALL SECTION	3
A-312	Scale: 1" = 1'-0"	

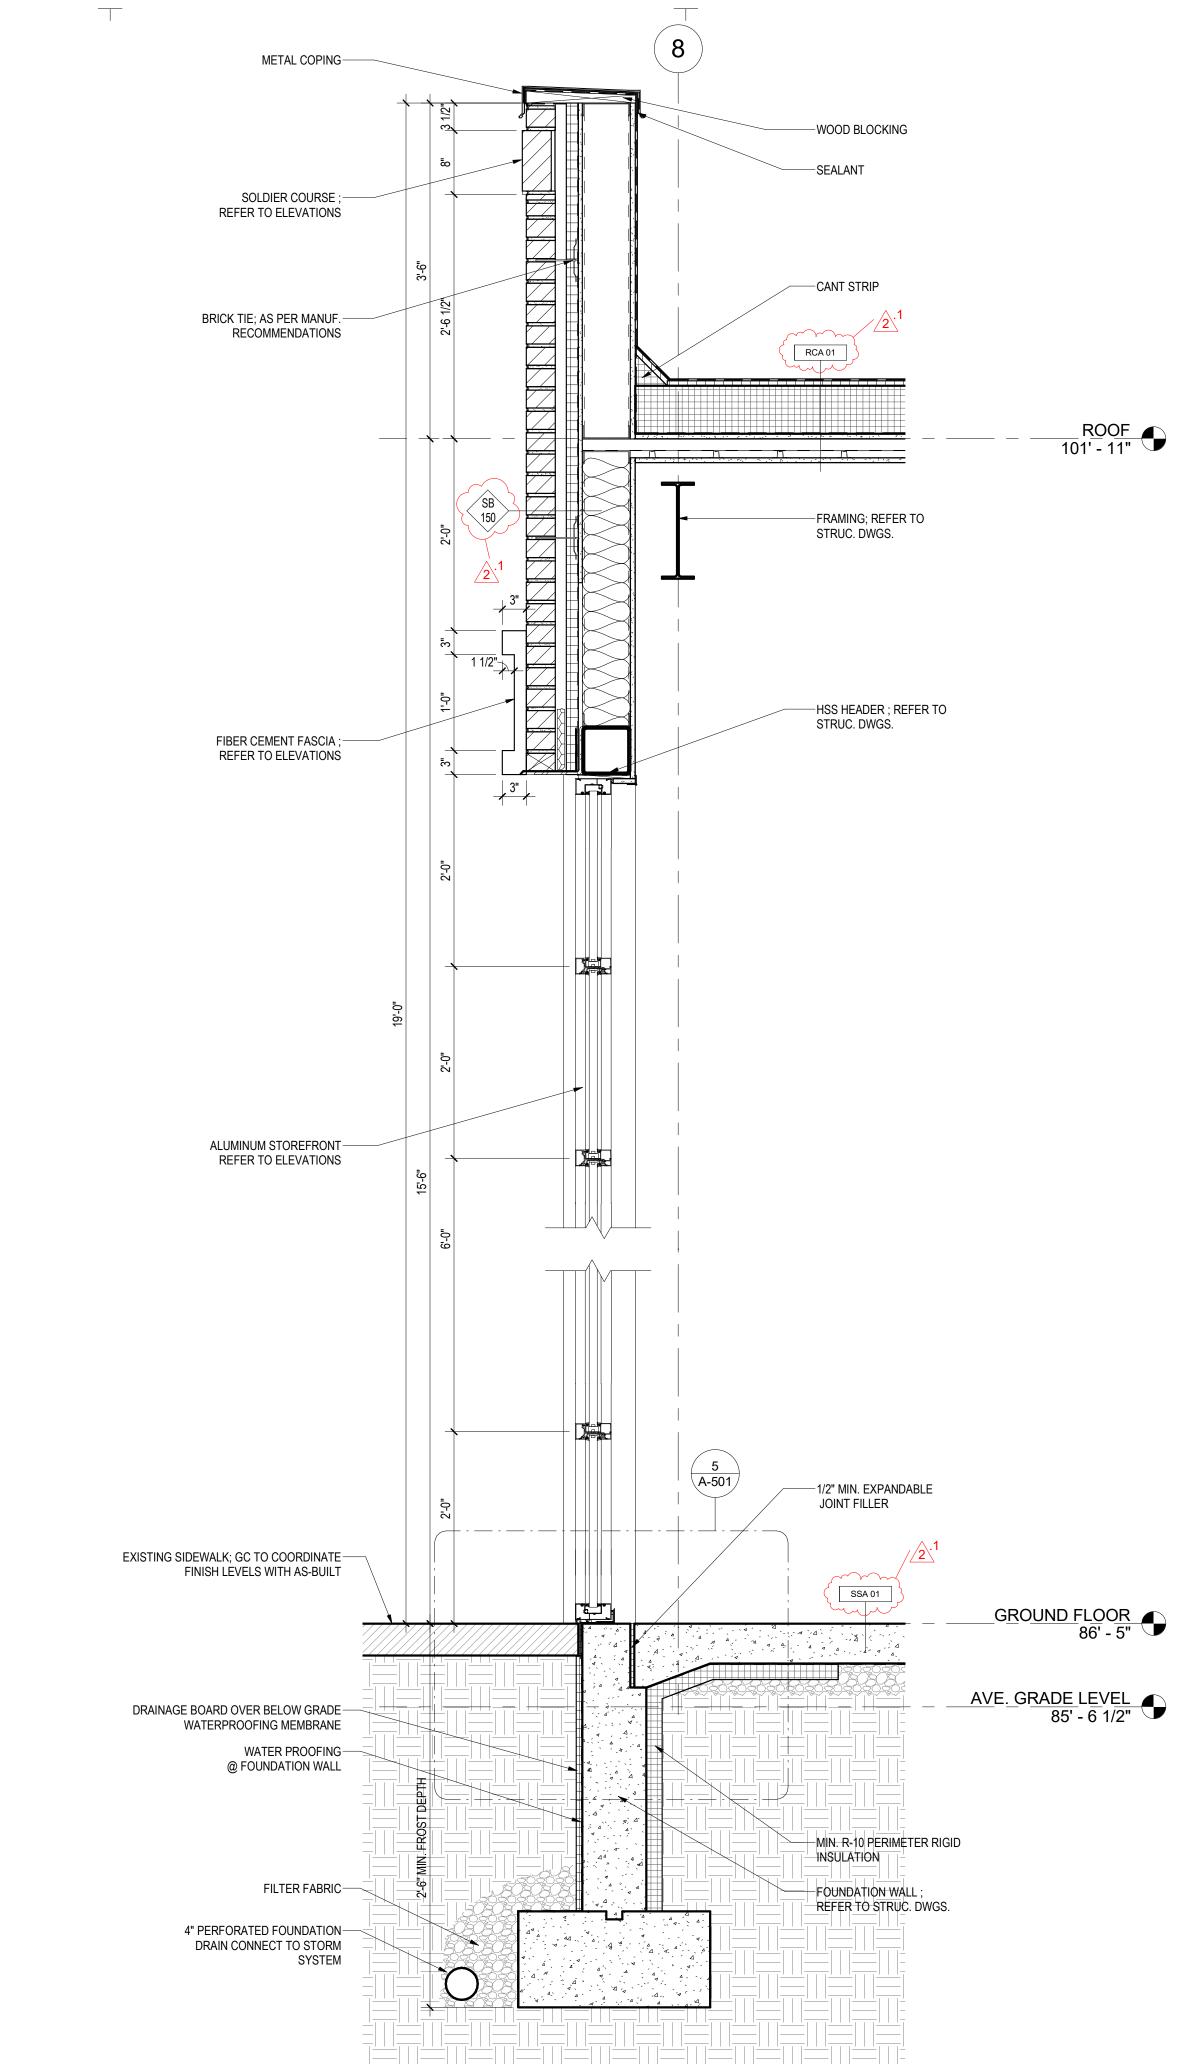Icesburg Pike   Suita 21 Leesburg Pike   Suita 21 SEAL & SIGNA	<b>I G N</b> e 700   Vienna, VA : 571.830.1801 esign.com
OWNER: PRINCE GEORGE REDEVELOP AUTHOR	PEMENT
SUITLAND RETAIL KIOSK PRINCE GEORGE'S COUNTY, MD	SHEET TITLE: WALL SECTIONS
IIIIIIIIIIIIIIIIIIIIIIIIIIIIIIIIIIII	NSE 08.14.2023 12.21.2022
	D E S 8521 Leesburg Pike   Suit 22182 P: 571.830.1800   F: www.Lessardde SEAL & SIGN/ SEAL & SIGN/ OWNER: PRINCE GEORGE REDEVELOP AUTHOR NON YOUNG SET NON CESCIPTION PROJECT NO: DRWR SET NO. DESCRIPTION PROJECT NO: DRWN BD BY:




ARCHITECT: **GENERAL NOTES** 1. REFER TO SHEET G-030 FOR WALL/ FLOOR/ROOF ASSEMBLY DETAILS. SEE A-200 SERIES FOR ELEVATIONS AND EXTERIOR WINDOW KEY REFERENCES. SEE A-300 SERIES DRAWING FOR BUILDING AND WALL SECTIONS. SEE A-500 FOR SPECIFIC BUILDING DETAILS. SEE A-600 SERIES FOR SCHEDULES. 5. EXTERIOR BUILDING DIMENSIONS ARE FROM TO THE EXTERIOR FACE OF STUD OR UNFINISHED WALL UNLESS NOTED OTHERWISE. GC TO COORDINATE EXISTING SIDEWALK FINISH LEVELS WITH AS-BUILT. - 7 GC TO CONFIRM EXISTING SIDEWALK SLOPES AWAY FROM ALL BUILDING DOORS AND WALLS. PROVIDE EXPANSION JOINT AT THE EDGE OF CONCRETE PAVING ABUTTING VERTICAL WALLS. 2.4 **REVISION #2 SUMMARY** G .1 WALL SECTION EXPANDED TO INCLUDE PLANTER ROOF 101' - 11" 2 WALL SECTION 6 ADDED
.3 WALL/FLOOR/ROOF ASSEMBLY TYPES INDICATED 8521 Leesburg Pike | Suite 700 | Vienna, VA 22182 .4 NOTES ADDED P: 571.830.1800 | F: 571.830.1801 www.Lessarddesign.com SEAL & SIGNATURE: OWNER: PRINCE GEORGE'S COUNTY REDEVELOPEMENT AUTHORITY SUITLAND RETAIL KIOSK PRINCE GEORGE'S COUNTY, MD SECTIONS WALL 5 ← _ REVISION 2 - RFI RESPONSE PERMIT SET 08.14.20 12.21.20 DESCRIPTION NO. DATE PROJECT No: TRUE NORTH CJR.001A.00 PLAN NORTH DRAWN BY Aut CHECKED BY PLOT DATE: FILE NAME: Chec 8/17/2023 2:45:40 PM **KEY PLAN** A-313

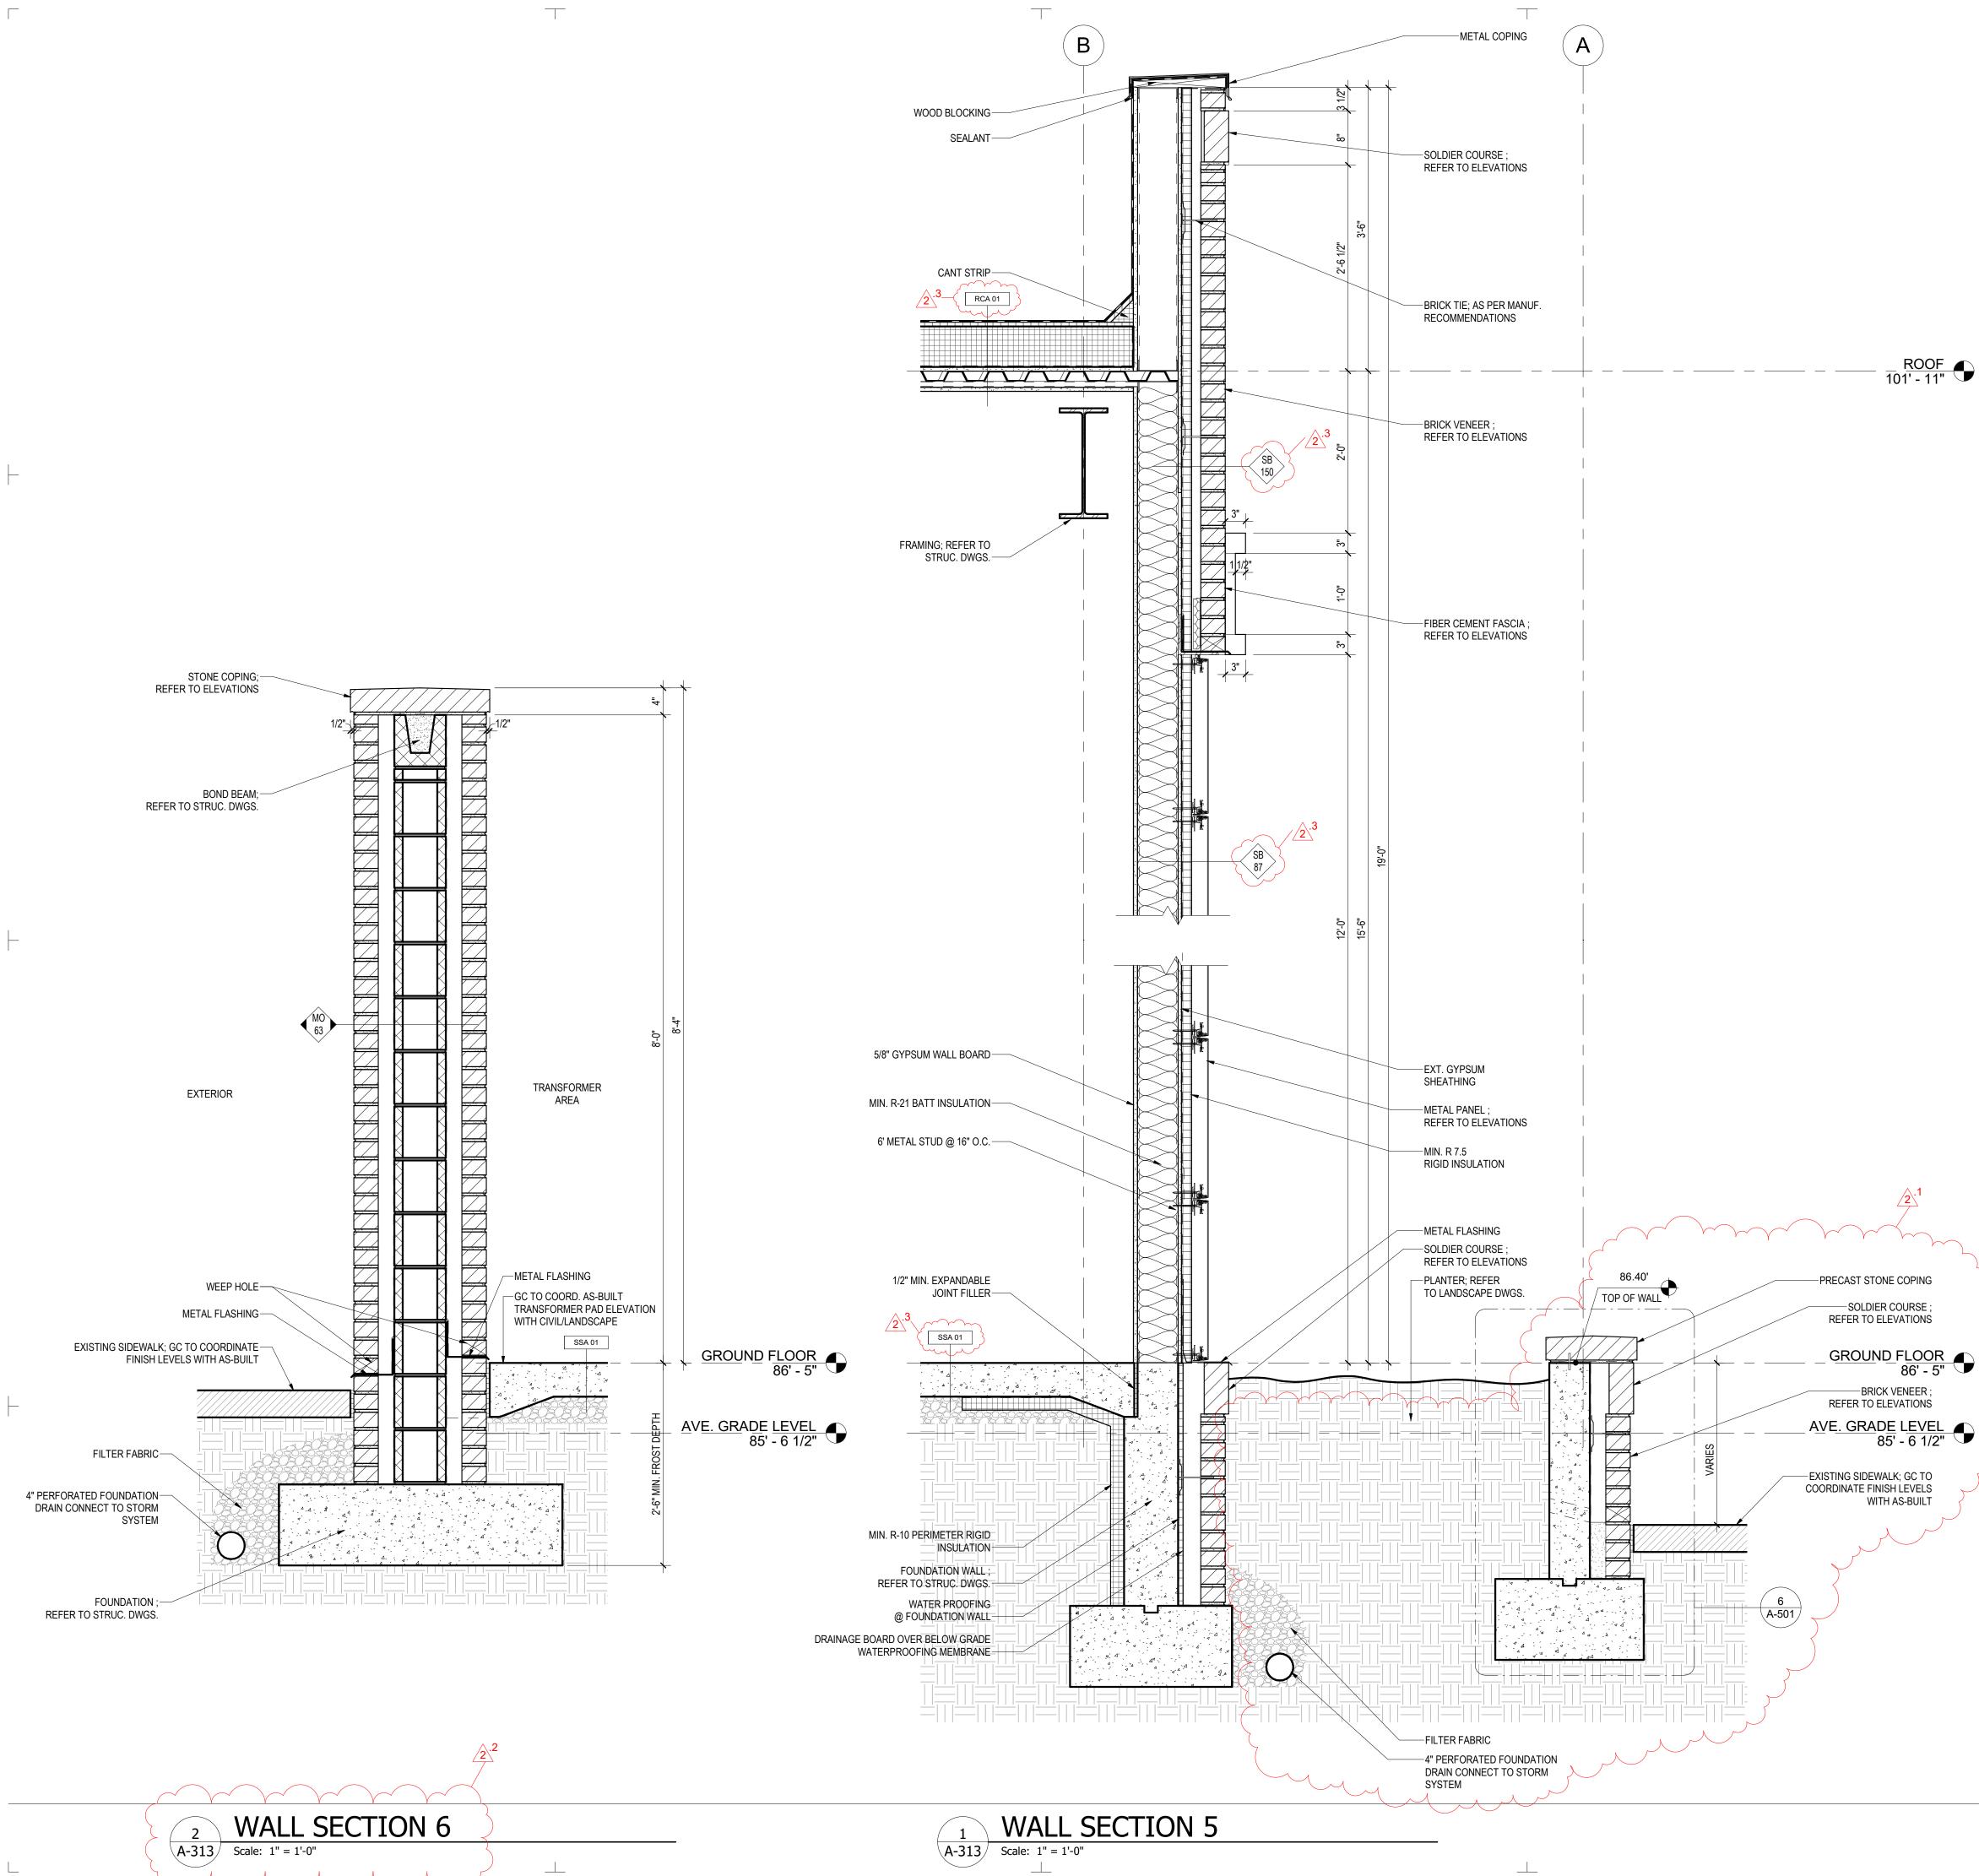


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4.	SEE A-500 FOR SPECIFIC BUILDING DETAILS.			
5.	SEE A-600 SERIES FOR SCHEDULES.		ou	
<mark>≻</mark> 6.	EXTERIOR BUILDING DIMENSIONS ARE FROM TO THE EXTERIOR FACE OF STUD OR UNFINISHED			て
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∽7. 8.	GC TO COORDINATE EXISTING SIDEWALK FINISH LEVELS WITH AS-BUILT.			
9.	PROVIDE EXPANSION JOINT AT THE EDGE OF CONCRETE PAVING ABUTTING VERTICAL WALLS.			oro
			ess	alc
	REVISION #2 SUMMARY	D	E S	GN
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			P: 571.830.1800   F: www.Lessardde	
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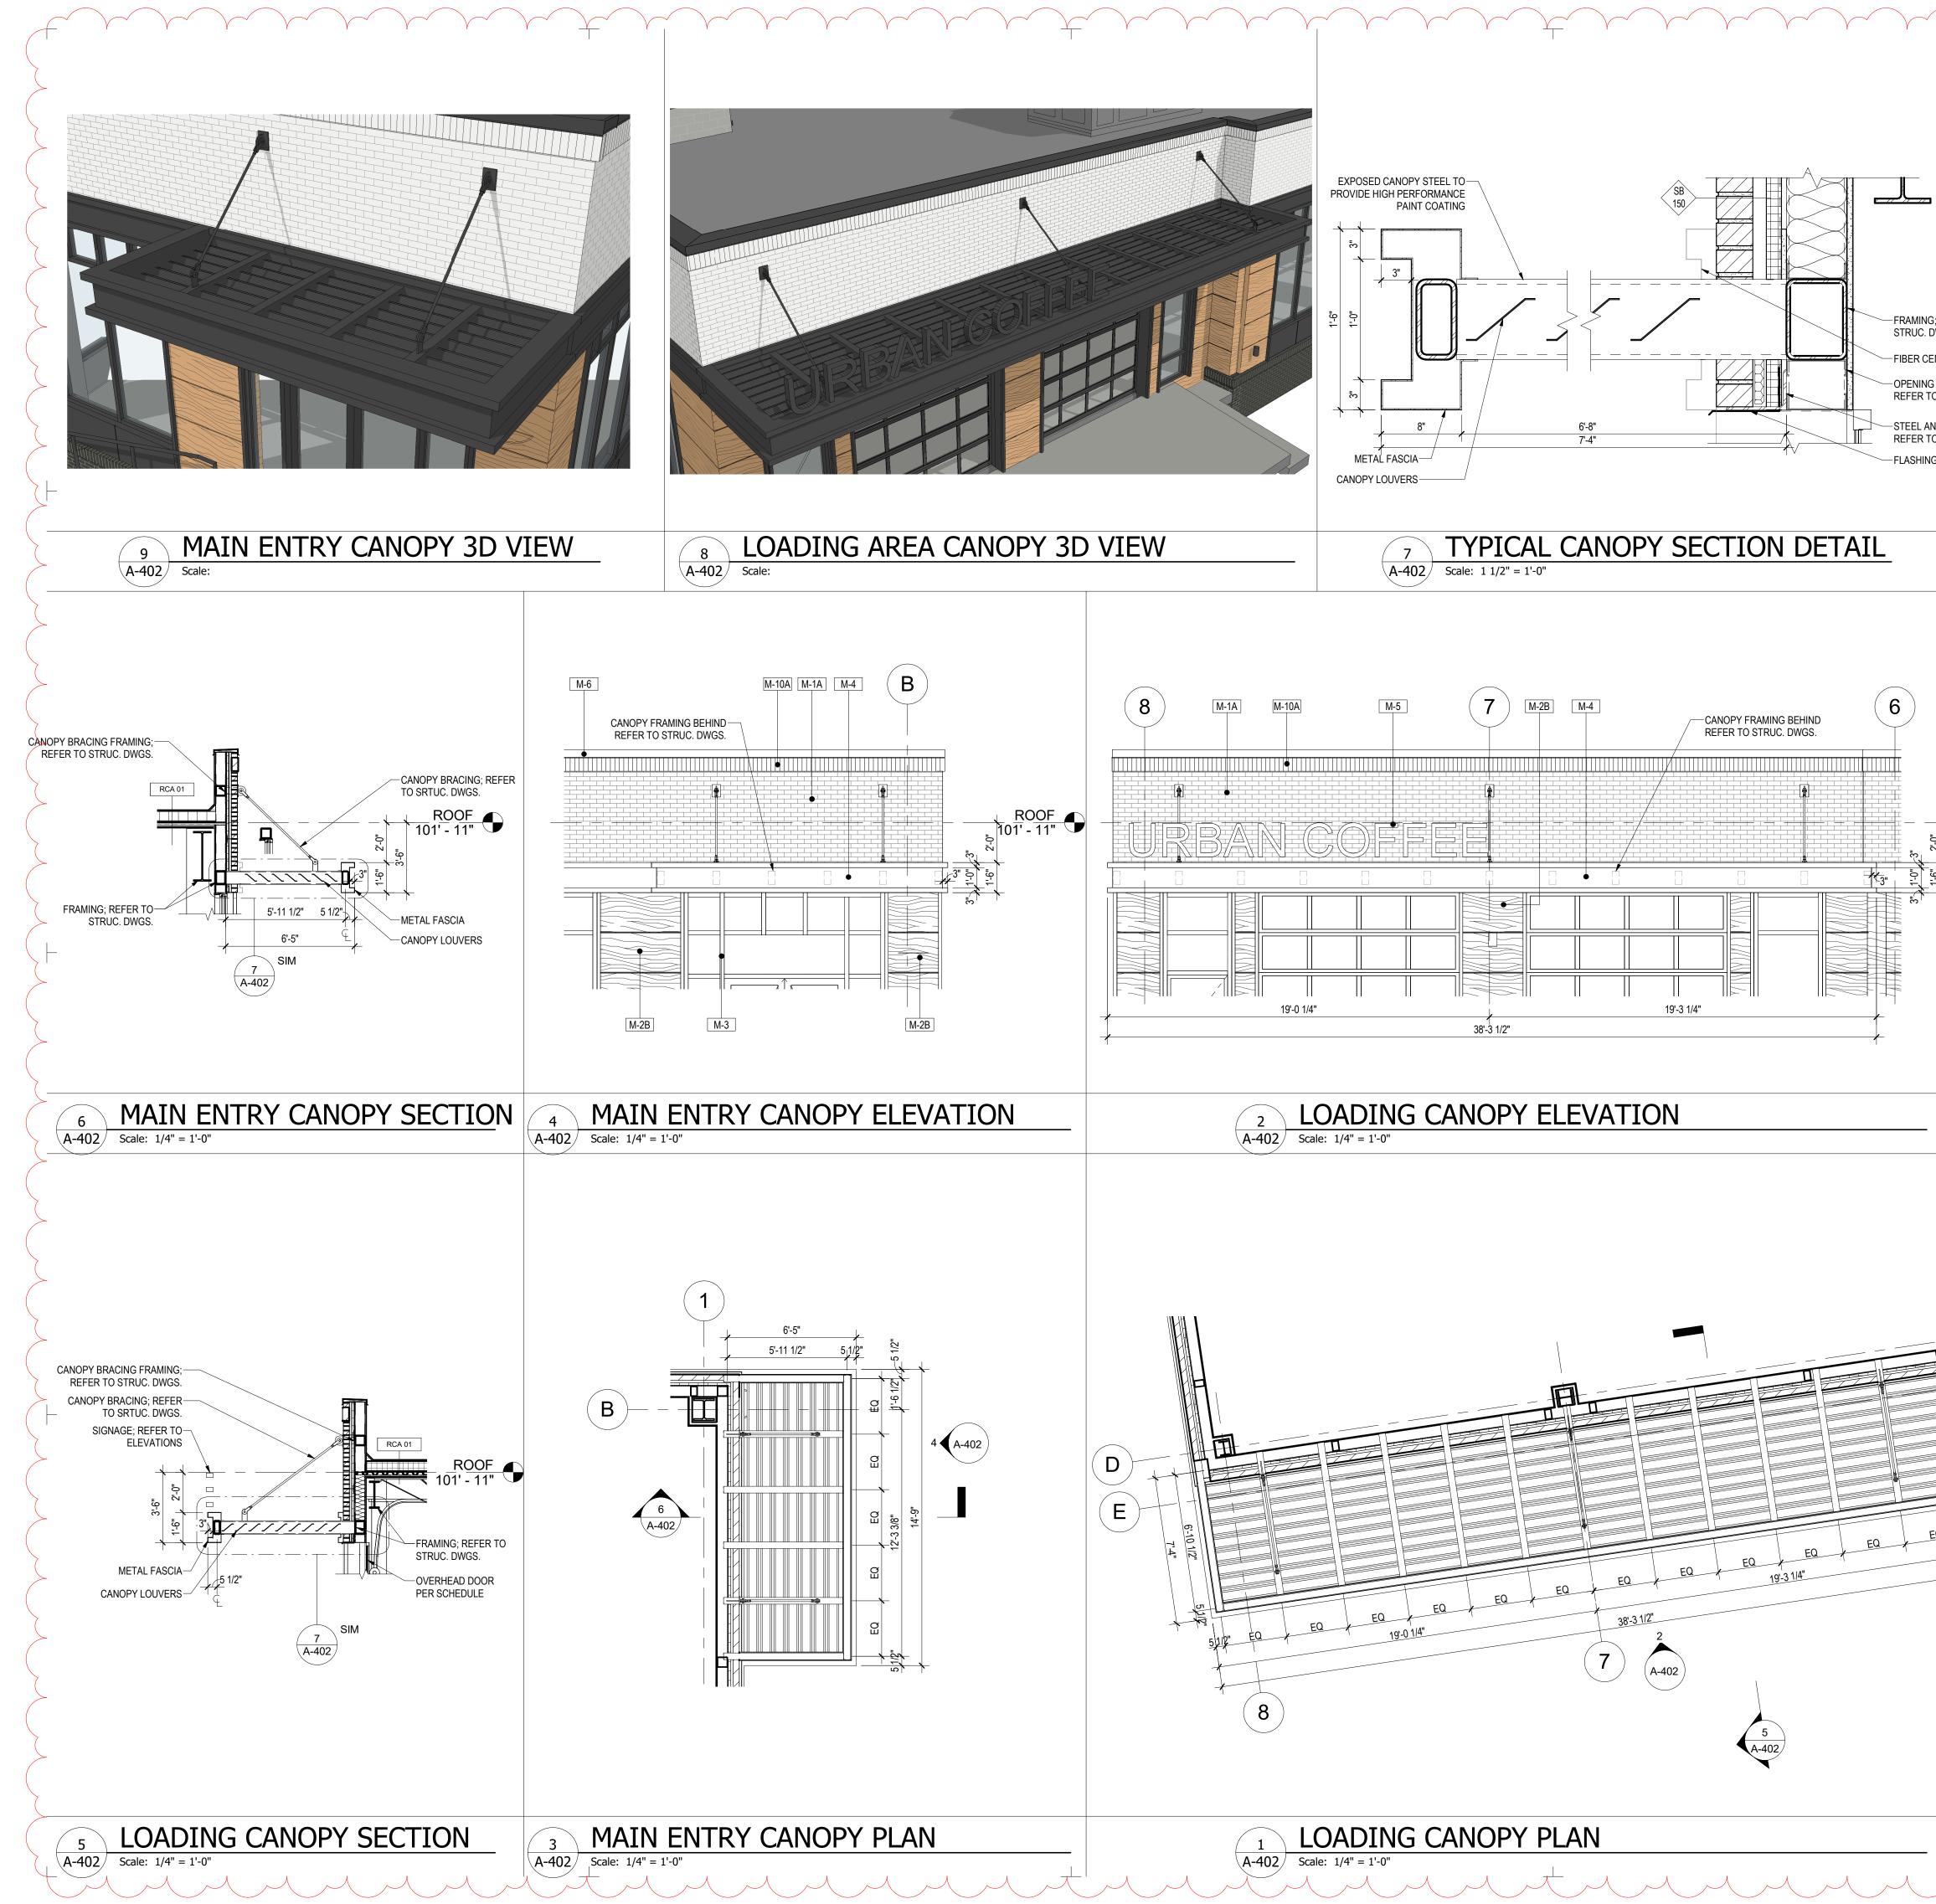
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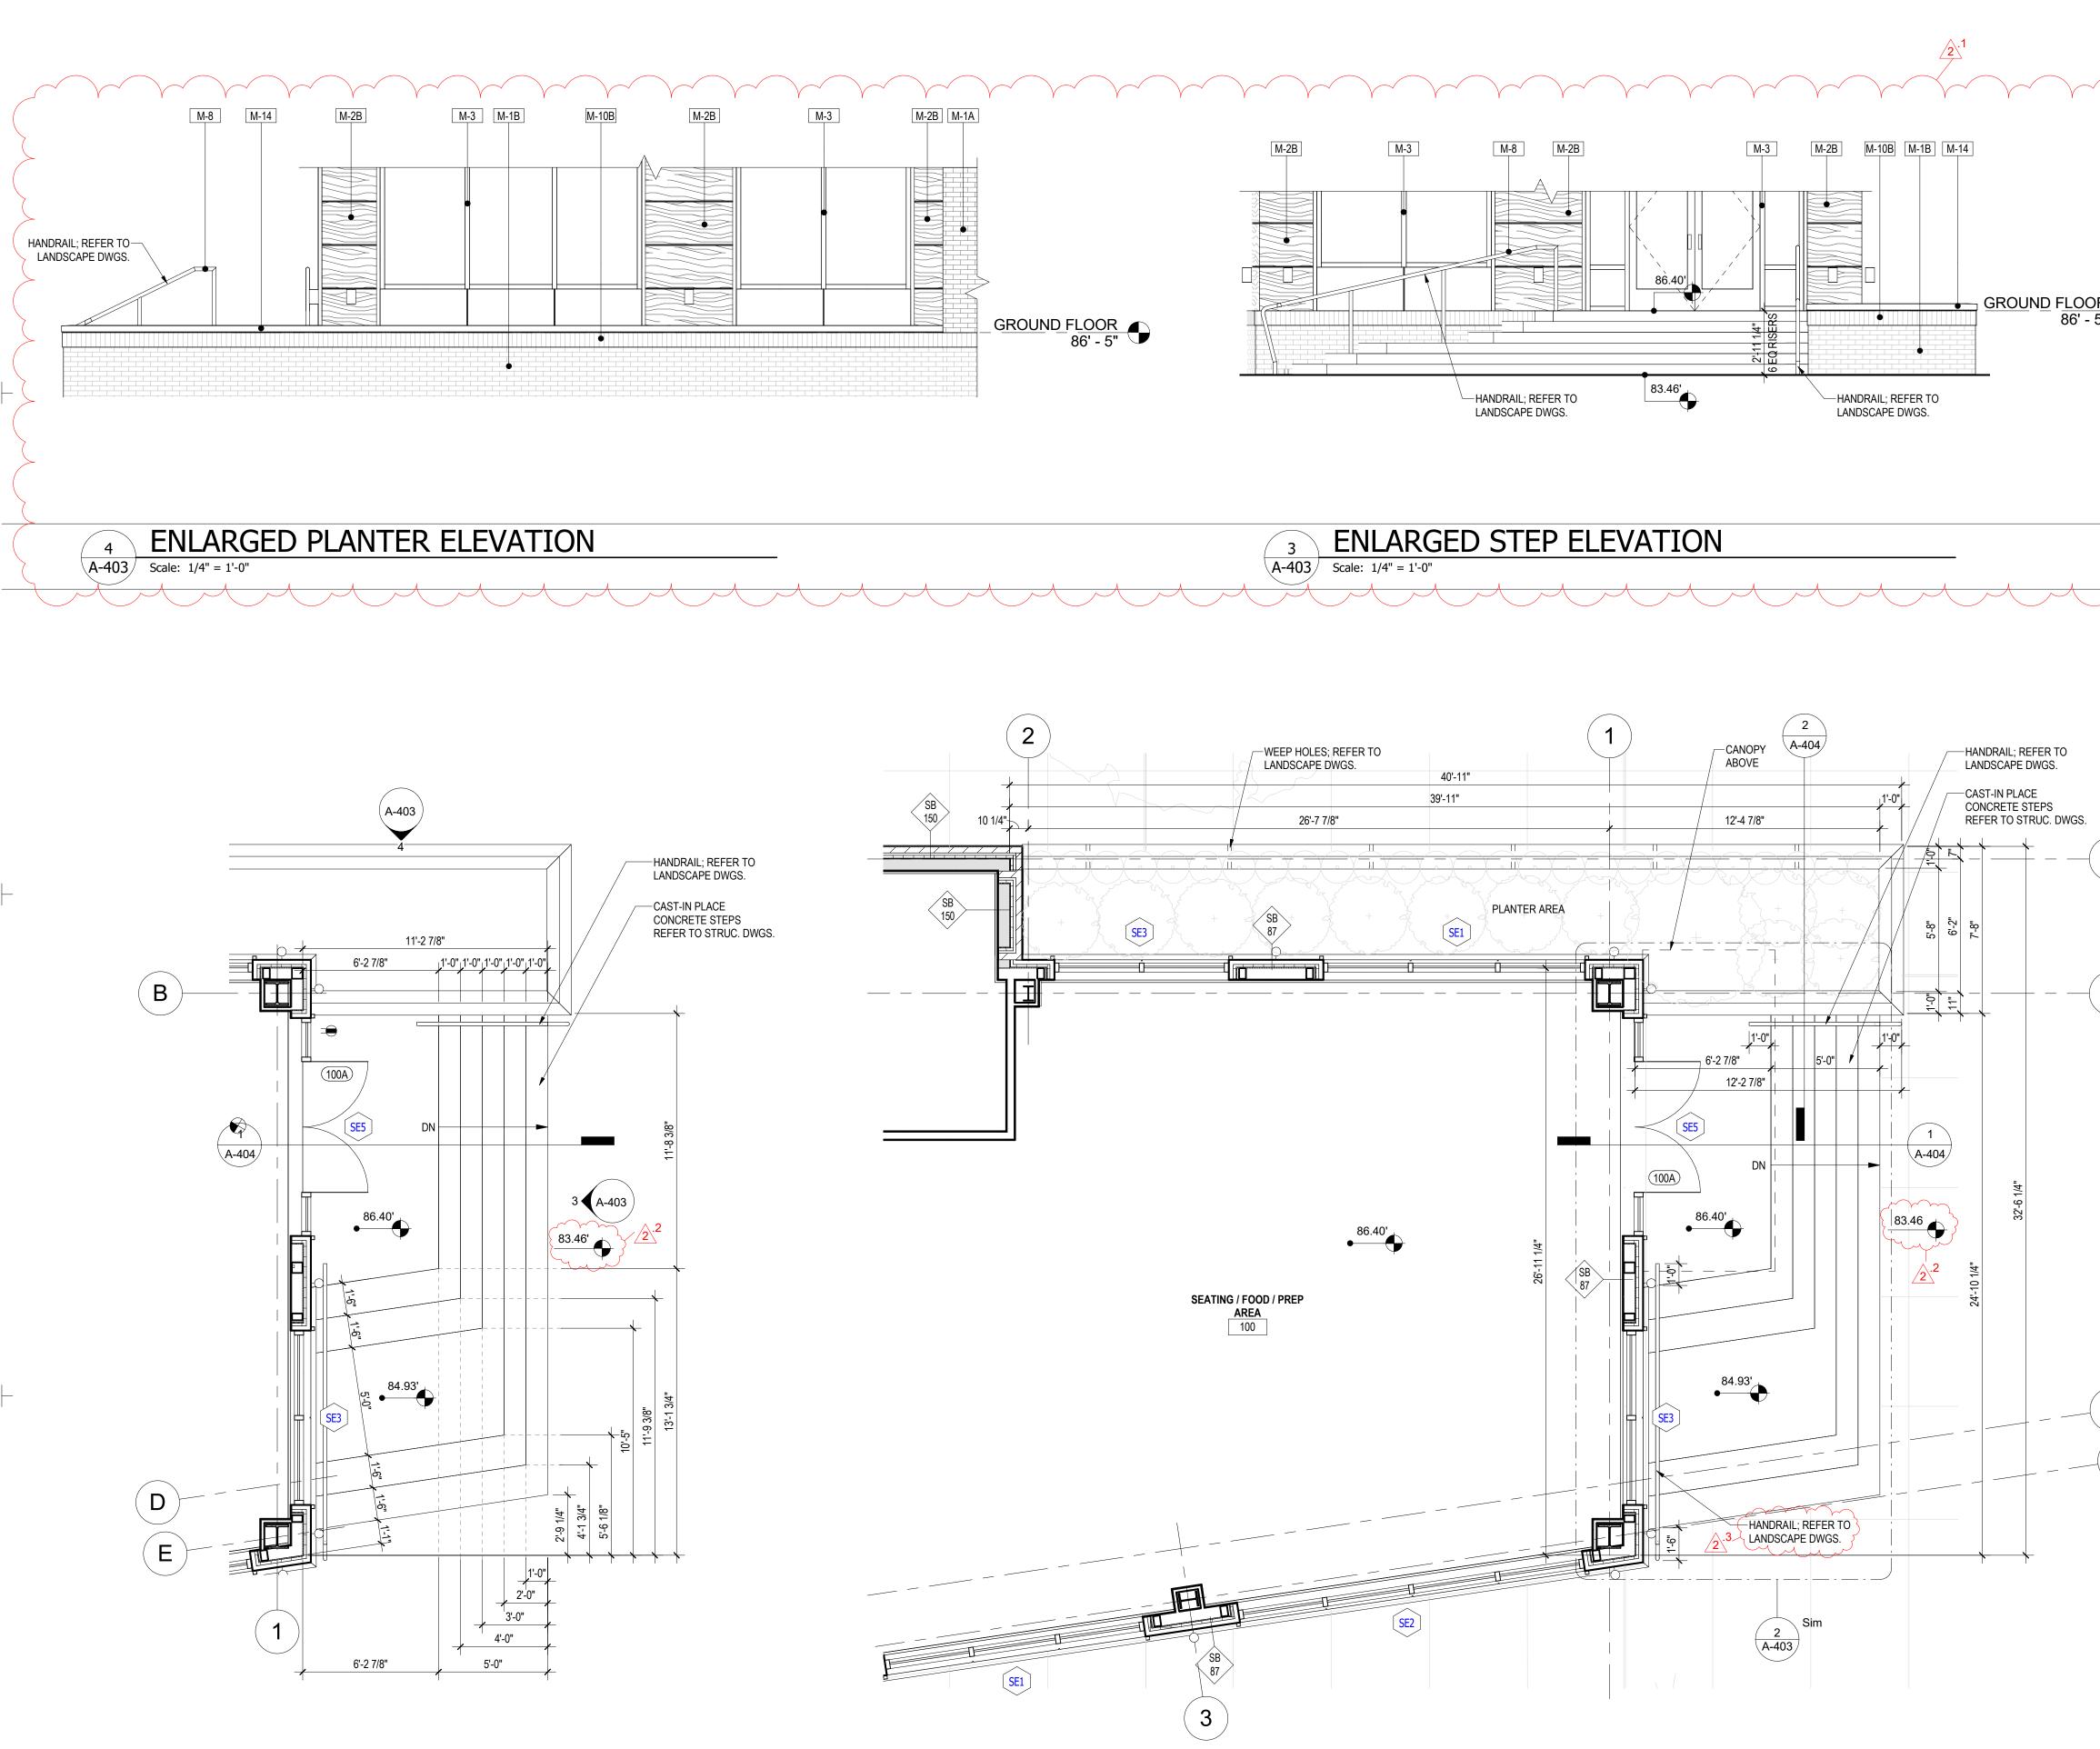
ACCESSORY 3 BAR 36" 3 BAR 18" 3 BAR 42" ET PAPER HOLDER 80R, 48" W X 36" H GUARD EL/WASTE UNIT E HOOK AL	5" BOBRICK 5806 SERIE 3" BOBRICK 5806 SERIE 2" BOBRICK 5806 SERIE 3R HOLDER BOBRICK B-4288 W X 36" H TRUEBRO SOFT HUA PLUS	S LOCATION & HEIGHTS REFER TO G-024 FOR MOUNTING S LOCATION & HEIGHTS REFER TO G-024 FOR MOUNTING	
B BAR 18" B BAR 42" ET PAPER HOLDER OR, 48" W X 36" H GUARD EL/WASTE UNIT E HOOK	BOBRICK 5806 SERIE BOBRICK 5806 SERIE R HOLDER BOBRICK B-4288 W X 36" H TRUEBRO SOFT HUA PLUS TE UNIT BOBRICK B-38034	S LOCATION & HEIGHTS REFER TO G-024 FOR MOUNTING S LOCATION & HEIGHTS REFER TO G-024 FOR MOUNTING LOCATION & HEIGHTS REFER TO G-024 FOR MOUNTING MAX 40" AFF TO REFLECTING SURFACE RD MOUNT DISPENSER MAX 44" AFF RECESSED PAPER TOWEL DISPENSER/ WASTE	
3 BAR 42" ET PAPER HOLDER ROR, 48" W X 36" H GUARD EL/WASTE UNIT E HOOK	BOBRICK 5806 SERIE       R HOLDER     BOBRICK B-4288       W X 36" H     TRUEBRO SOFT HUA       PLUS     TE UNIT	S LOCATION & HEIGHTS REFER TO G-024 FOR MOUNTING LOCATION & HEIGHTS REFER TO G-024 FOR MOUNTING MAX 40" AFF TO REFLECTING SURFACE RD MOUNT DISPENSER MAX 44" AFF RECESSED PAPER TOWEL DISPENSER/ WASTE	
et paper holder Ror, 48" w x 36" h Guard El/waste unit E hook	R HOLDER BOBRICK B-4288 W X 36" H TRUEBRO SOFT HUA PLUS TE UNIT BOBRICK B-38034	LOCATION & HEIGHTS REFER TO G-024 FOR MOUNTING MAX 40" AFF TO REFLECTING SURFACE RD MOUNT DISPENSER MAX 44" AFF RECESSED PAPER TOWEL DISPENSER/ WASTE	
ROR, 48" W X 36" H GUARD EL/WASTE UNIT E HOOK	W X 36" H TRUEBRO SOFT HUA PLUS TE UNIT BOBRICK B-38034	MAX 40" AFF TO REFLECTING SURFACE RD MOUNT DISPENSER MAX 44" AFF RECESSED PAPER TOWEL DISPENSER/ WASTE	
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		_	www.Lessarddesign.com SEAL & SIGNATURE:
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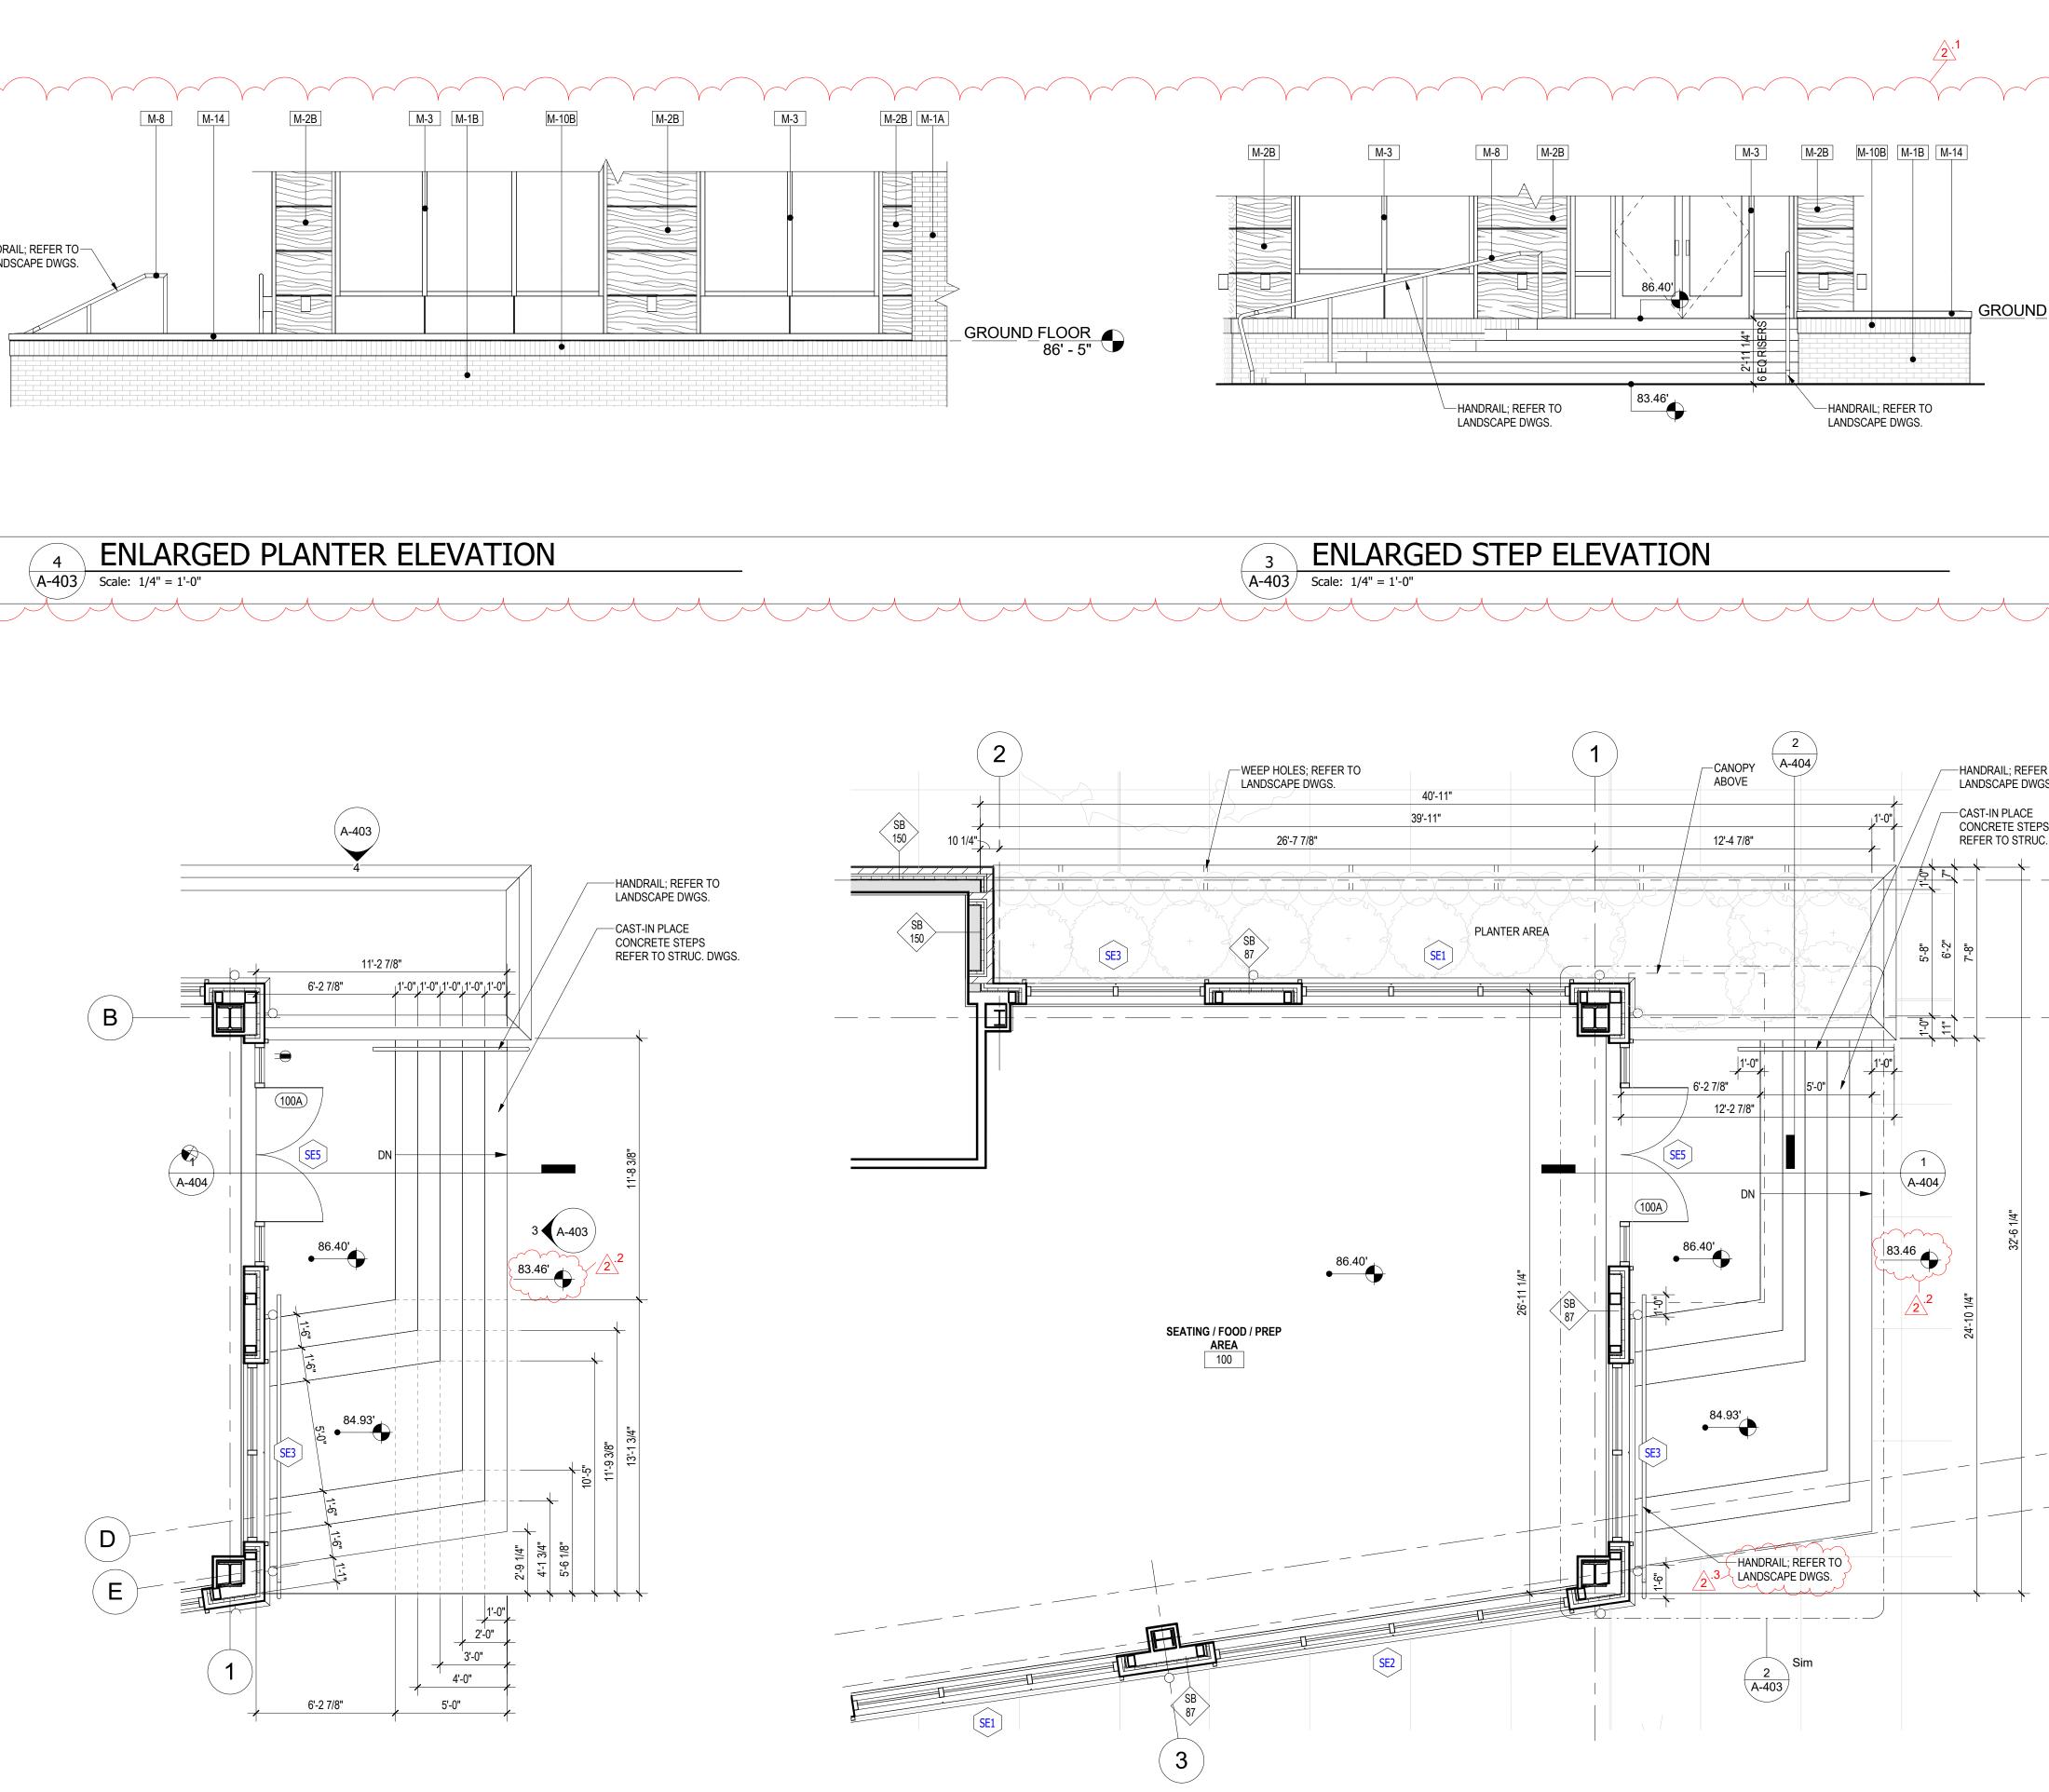
PROJECT NAME:	SUITLAND RETAIL KIOSK	PRINCE GEORGE'S COUNTY, MD	REFITTLE: RESTROOM FNI ARGED PI ANS AND	ELEVATIONS
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REDEVELOPEMENT AUTHORITY



			2.1	ARCHITECT:	
	NO.	MATERIAL SCHEDULE MATERIAL		ARCHITECT.	
-	M-1A M-1B	BRICK VENEER - BELDEN, ALASKA WHITE VELOUR, MODULAR BRICK VENEER - TAYLOR CLAY, BLACK ONYX WIRE CUT, MODULAR			
_	M-2A M-2B	METAL PANEL - ALUCOBOND TRI-CORN BLACK METAL PANEL - ALUCOBOND CHESTNUT			
2	M-3	ALUMINUM STOREFRONT SYSTEM - KAWNEER OR EFCO KYNAR STANDARD BLACK		24	$\sim$
-	M-4 M-5	METAL CANOPY - ALUCOBOND TRI-CORN BLACK NON-LIT SIGNAGE - TBD			
_	M-6 M-8 M-9	PARAPET COPING - ALUCOBOND TRI-CORN BLACK METAL RAILING - ALUCOBOND TRI-CORN BLACK FIRED CEMENT FASCIA, ALUCODOND TRI-CORN BLACK			
NG; REFER TO C. DWGS.	M-10A M-10B	FIBER CEMENT FASCIA - ALUCOBOND TRI-CORN BLACK         SOLDIER COURSE - WHITE         SOLDIER COURSE - BLACK		less	ard
CEMENT FASCIA BEYOND	M-105 M-11 M-12	FLUSH DOOR - ALUCOBOND TRI-CORN BLACK SECTIONAL OVERHEAD DOOR W/ FULL VISION GLASS - ALUCOBOND		DES	IGN
TO STRUC. DWGS.	M-13	TRI-CORN BLACK		8521 Leesburg Pike   S 221 P: 571.830.1800	82 F: 571.830.1801
ANGLE; R TO STRUC. DWGS.	M-14 M-15	PRECAST STONE COPING - TBD WALL SCONCE AT BUILDING PERIMETER		www.Lessarc SEAL & SIC	_
		SION #2 SUMMARY NOPY DETAIL VIEWS AND SHEET UPDATED			
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2. 3.	REFER TO SHEET G-030 FOR WALL/ FLOOR/ROOF ASSEMBLY DETAILS. SEE A-200 SERIES FOR ELEVATIONS AND EXTERIOR WINDOW KEY REFERENCES.	
3.	SEE A-200 SERIES FOR ELEVATIONS AND EXTERIOR WINDOW KEY REFERENCES.	
	SEE A-300 SERIES DRAWING FOR BUILDING AND WALL SECTIONS.	
4.		
	SEE A-500 FOR SPECIFIC BUILDING DETAILS.	
5.	SEE A-600 SERIES FOR SCHEDULES.	
6.	EXTERIOR BUILDING DIMENSIONS ARE FROM TO THE EXTERIOR FACE OF STUD OR UNFINISHED	
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7.	GC TO COORDINATE EXISTING SIDEWALK FINISH LEVELS WITH AS-BUILT.	
8.	GC TO CONFIRM EXISTING SIDEWALK SLOPES AWAY FROM ALL BUILDING DOORS AND WALLS.	
<b>\</b>	PROVIDE EXPANSION JOINT AT THE EDGE OF CONCRETE PAVING ABUTTING VERTICAL WALLS.	
)	MATERIAL SCHEDULE	8521 Leesburg Pike   Suite 700   Vienna,
		22182 P: 571.830.1800   F: 571.830.1801
NO.	MATERIAL	www.Lessarddesign.com
M-1A	BRICK VENEER - BELDEN, ALASKA WHITE VELOUR, MODULAR	SEAL & SIGNATURE:
M-18	BRICK VENEER - TAYLOR CLAY, BLACK ONYX WIRE CUT, MODULAR	
M-2A	METAL PANEL - ALUCOBOND TRI-CORN BLACK	
M-2B	METAL PANEL - ALUCOBOND CHESTNUT	
M-3	ALUMINUM STOREFRONT SYSTEM - KAWNEER OR EFCO KYNAR	
	STANDARD BLACK	
M-4	METAL CANOPY - ALUCOBOND TRI-CORN BLACK	
M-5	NON-LIT SIGNAGE - TBD	
M-6	PARAPET COPING - ALUCOBOND TRI-CORN BLACK	
M-8	METAL RAILING - ALUCOBOND TRI-CORN BLACK	
M-9	FIBER CEMENT FASCIA - ALUCOBOND TRI-CORN BLACK	
M-10A		OWNER:
M-10E M-11	SOLDIER COURSE - BLACK FLUSH DOOR - ALUCOBOND TRI-CORN BLACK	PRINCE GEORGE'S COUN
M-11 M-12	SECTIONAL OVERHEAD DOOR W/ FULL VISION GLASS - ALUCOBOND TRI-CORN BLACK	REDEVELOPEMENT
M-13	NOT USED	AUTHORITI
<b>U</b>	PRECAST STONE COPING - TBD	1
M-14		1
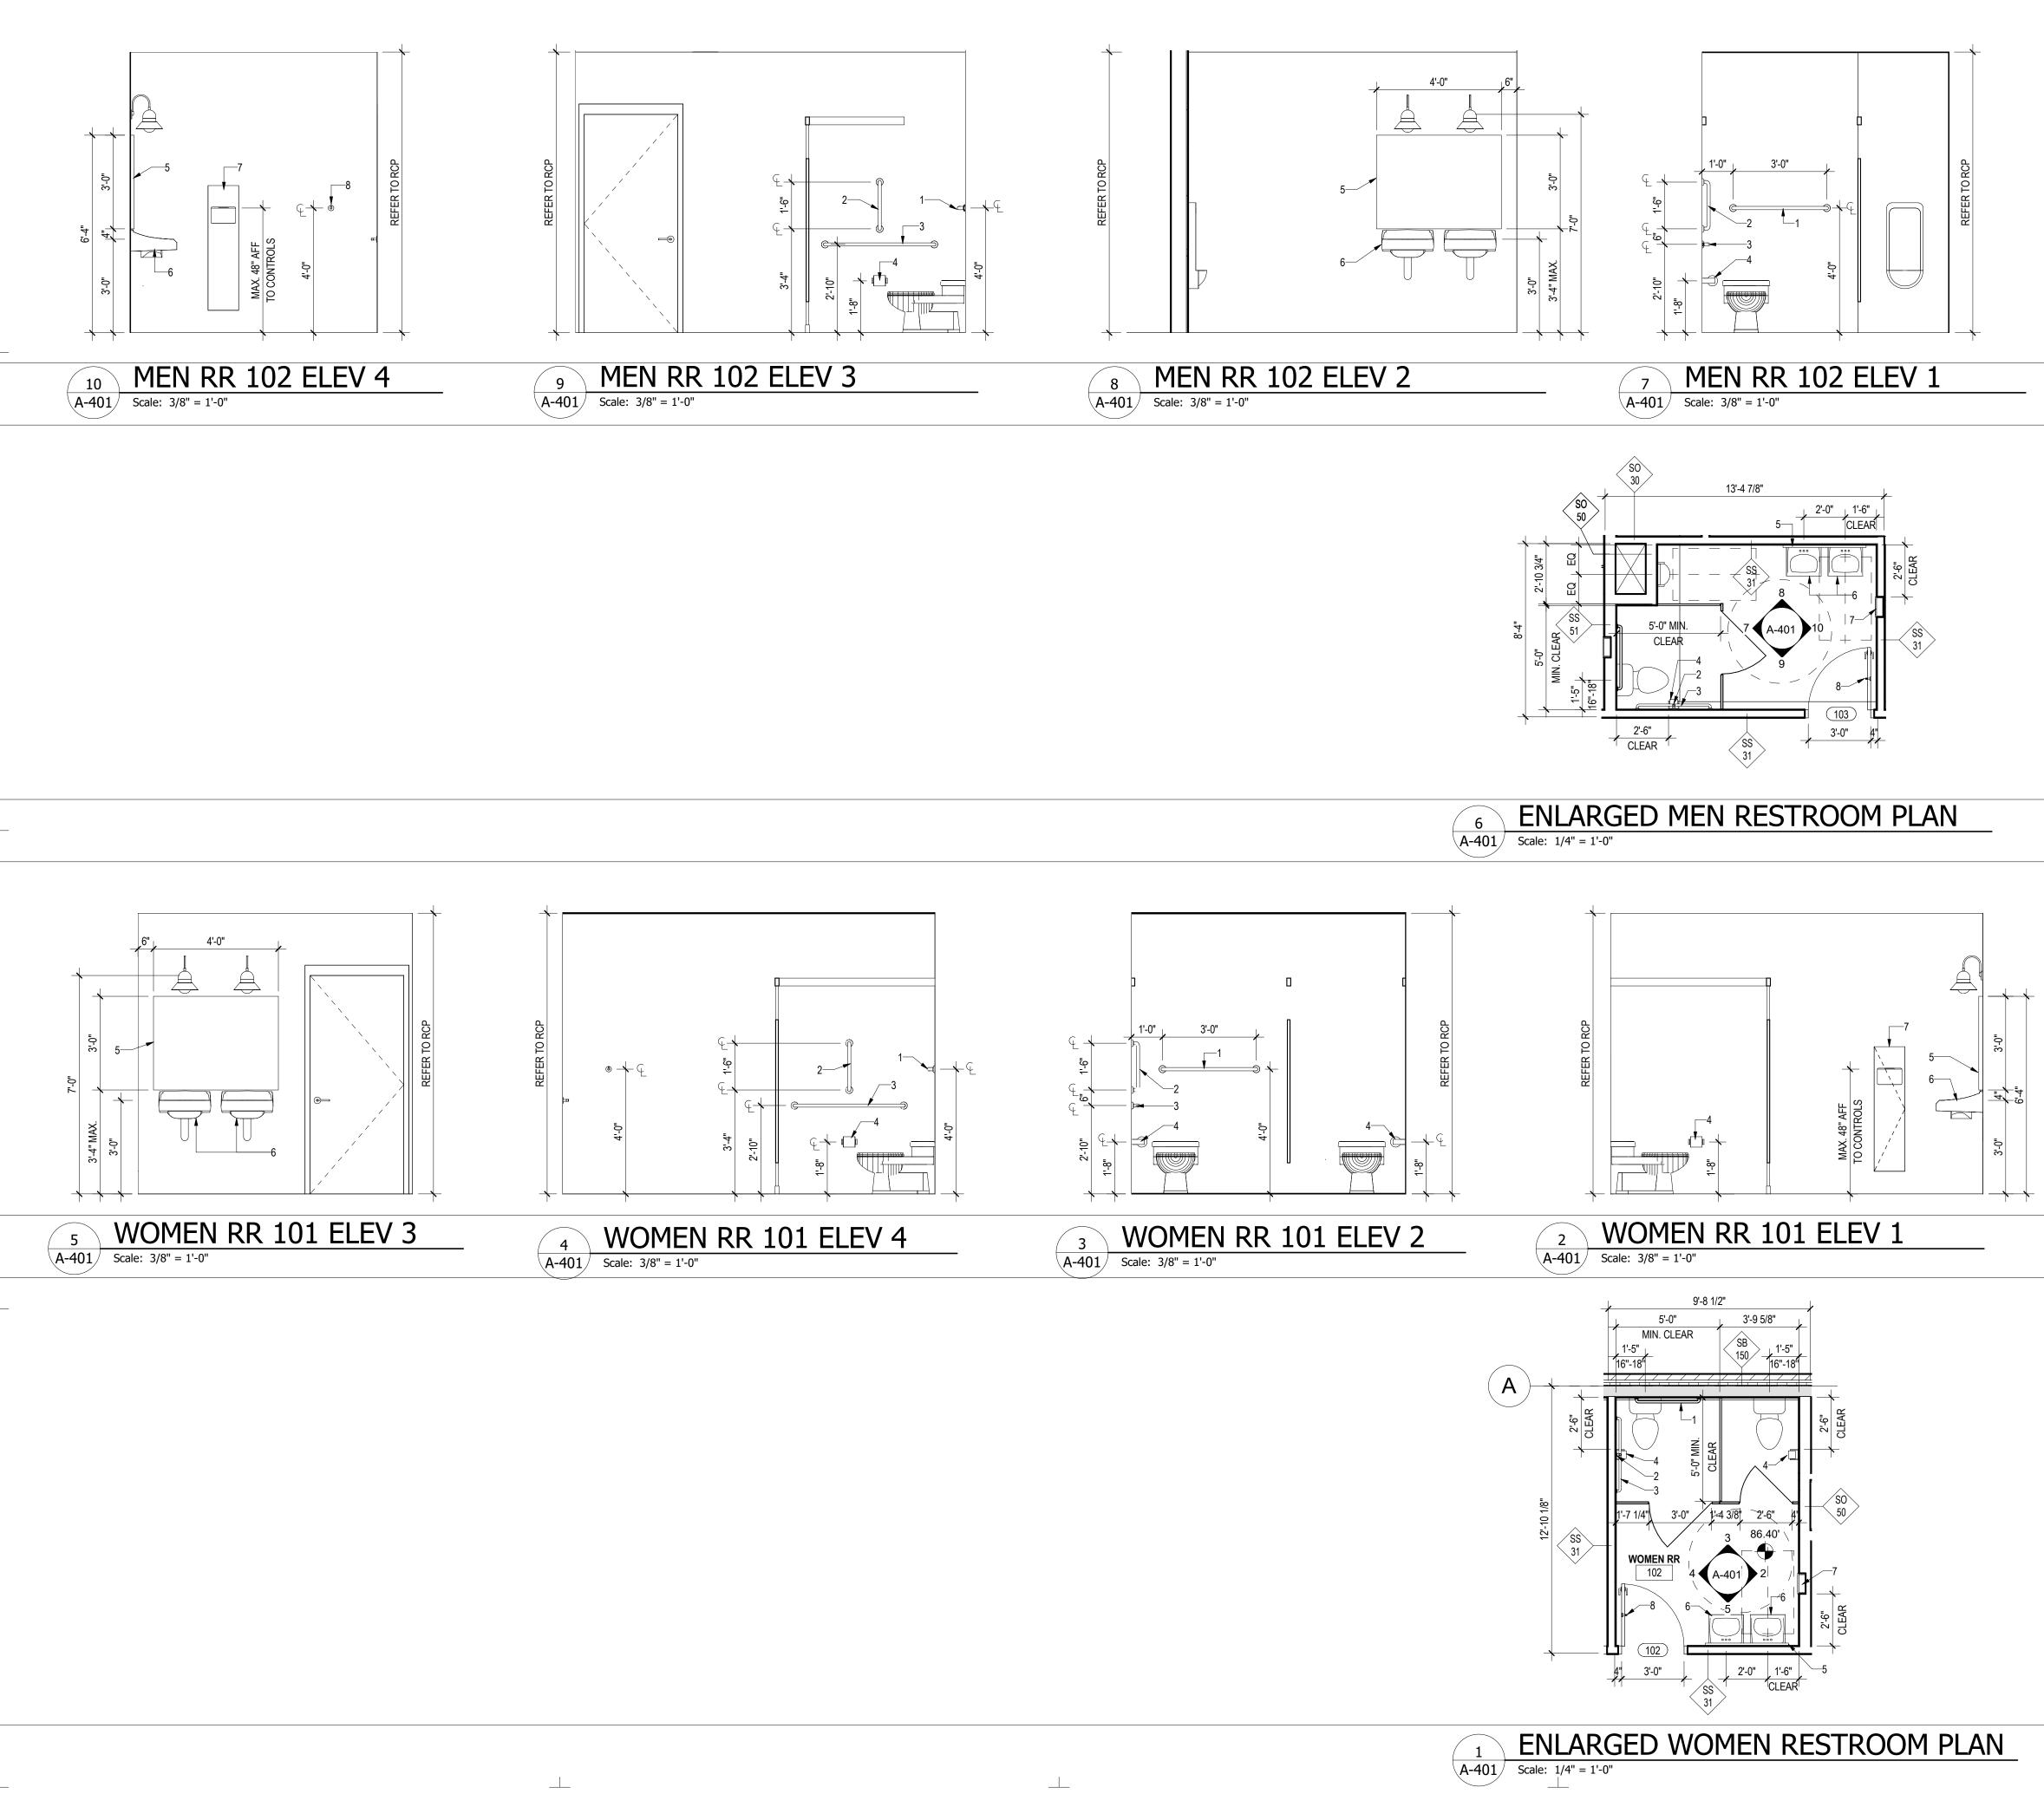
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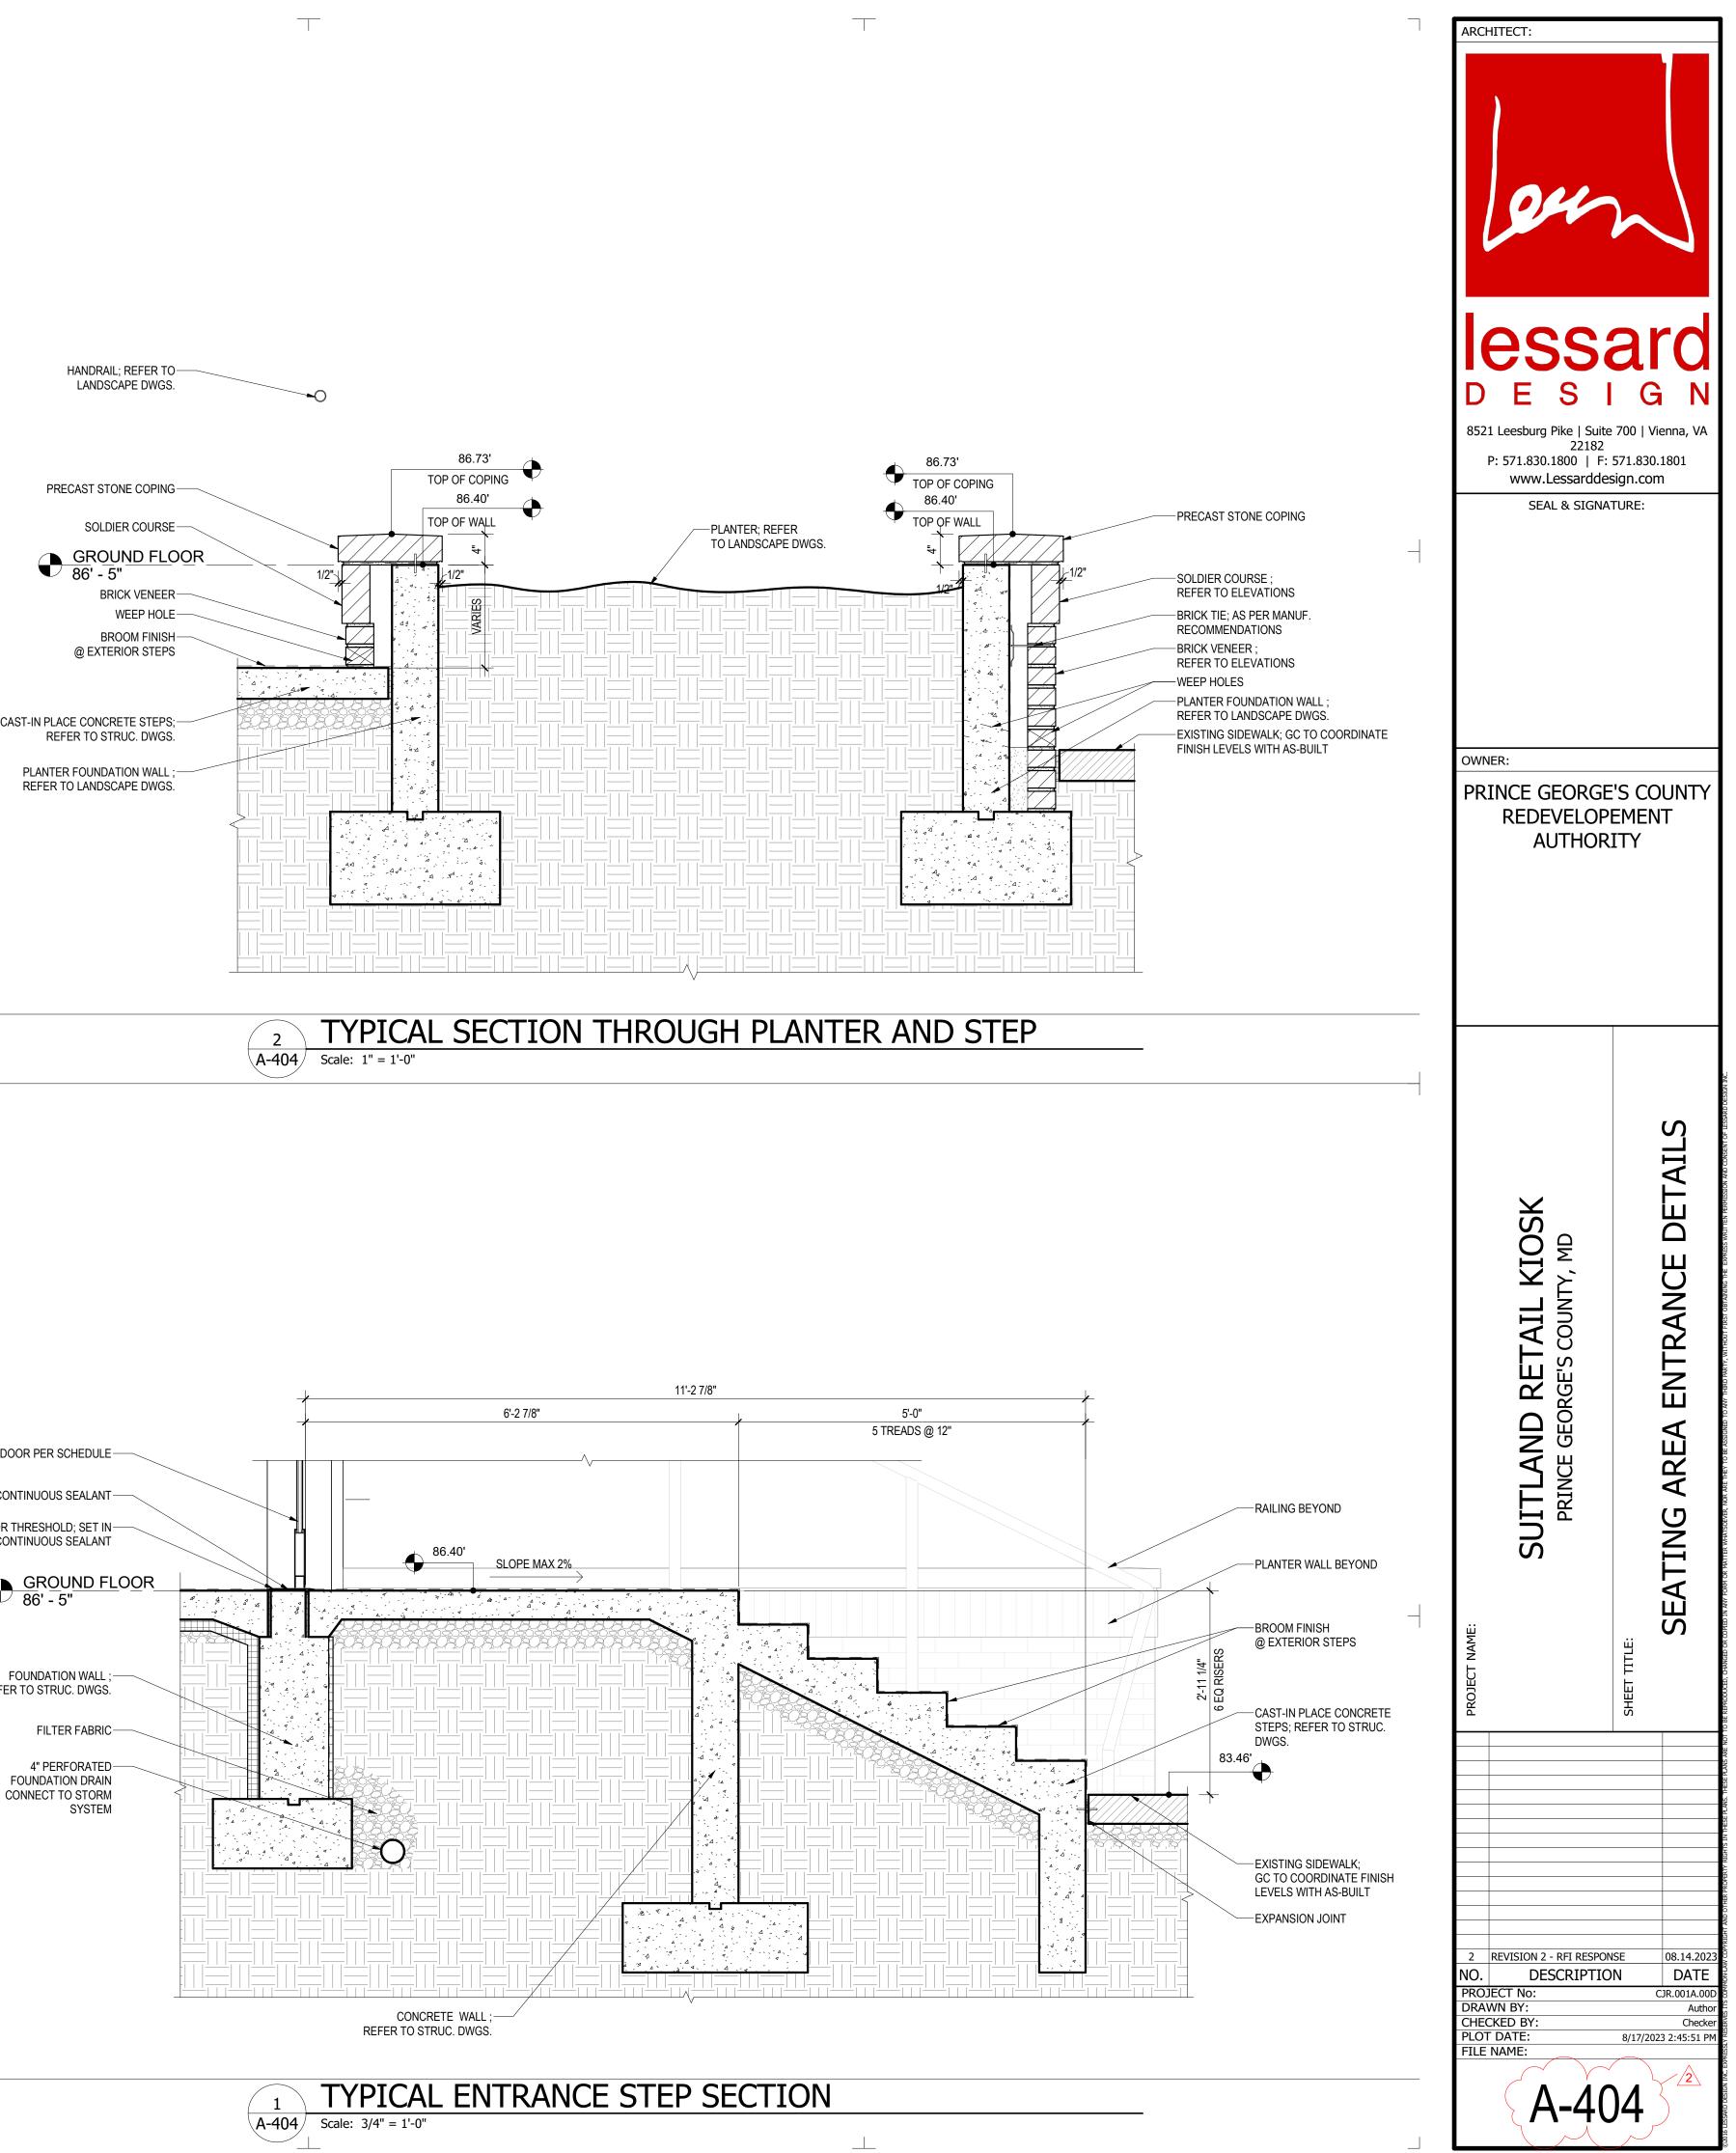
 
 REVISION 2 - RFI RESPONSE


 PERMIT SET
 08.14.20 12.21.20 DESCRIPTION DATE PROJECT No: DRAWN BY: CHECKED BY: PLOT DATE: FILE NAME: CJR.001A.00 Aut Checker 8/17/2023 2:45:49 PM A-403

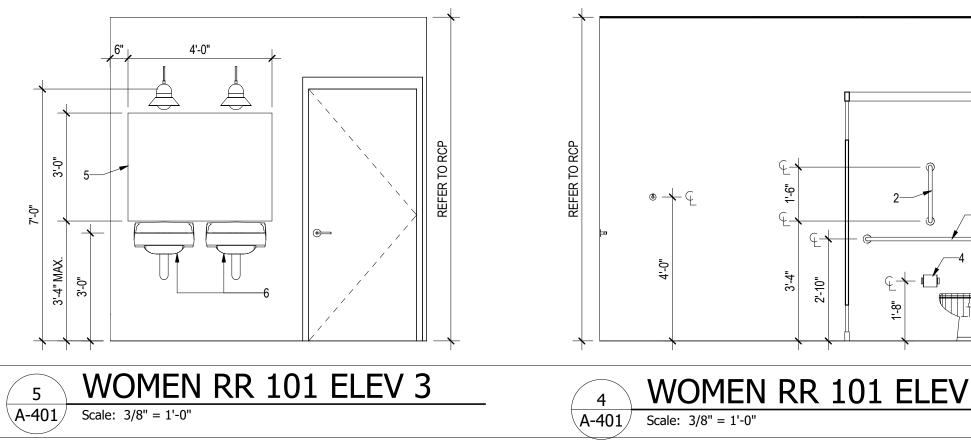
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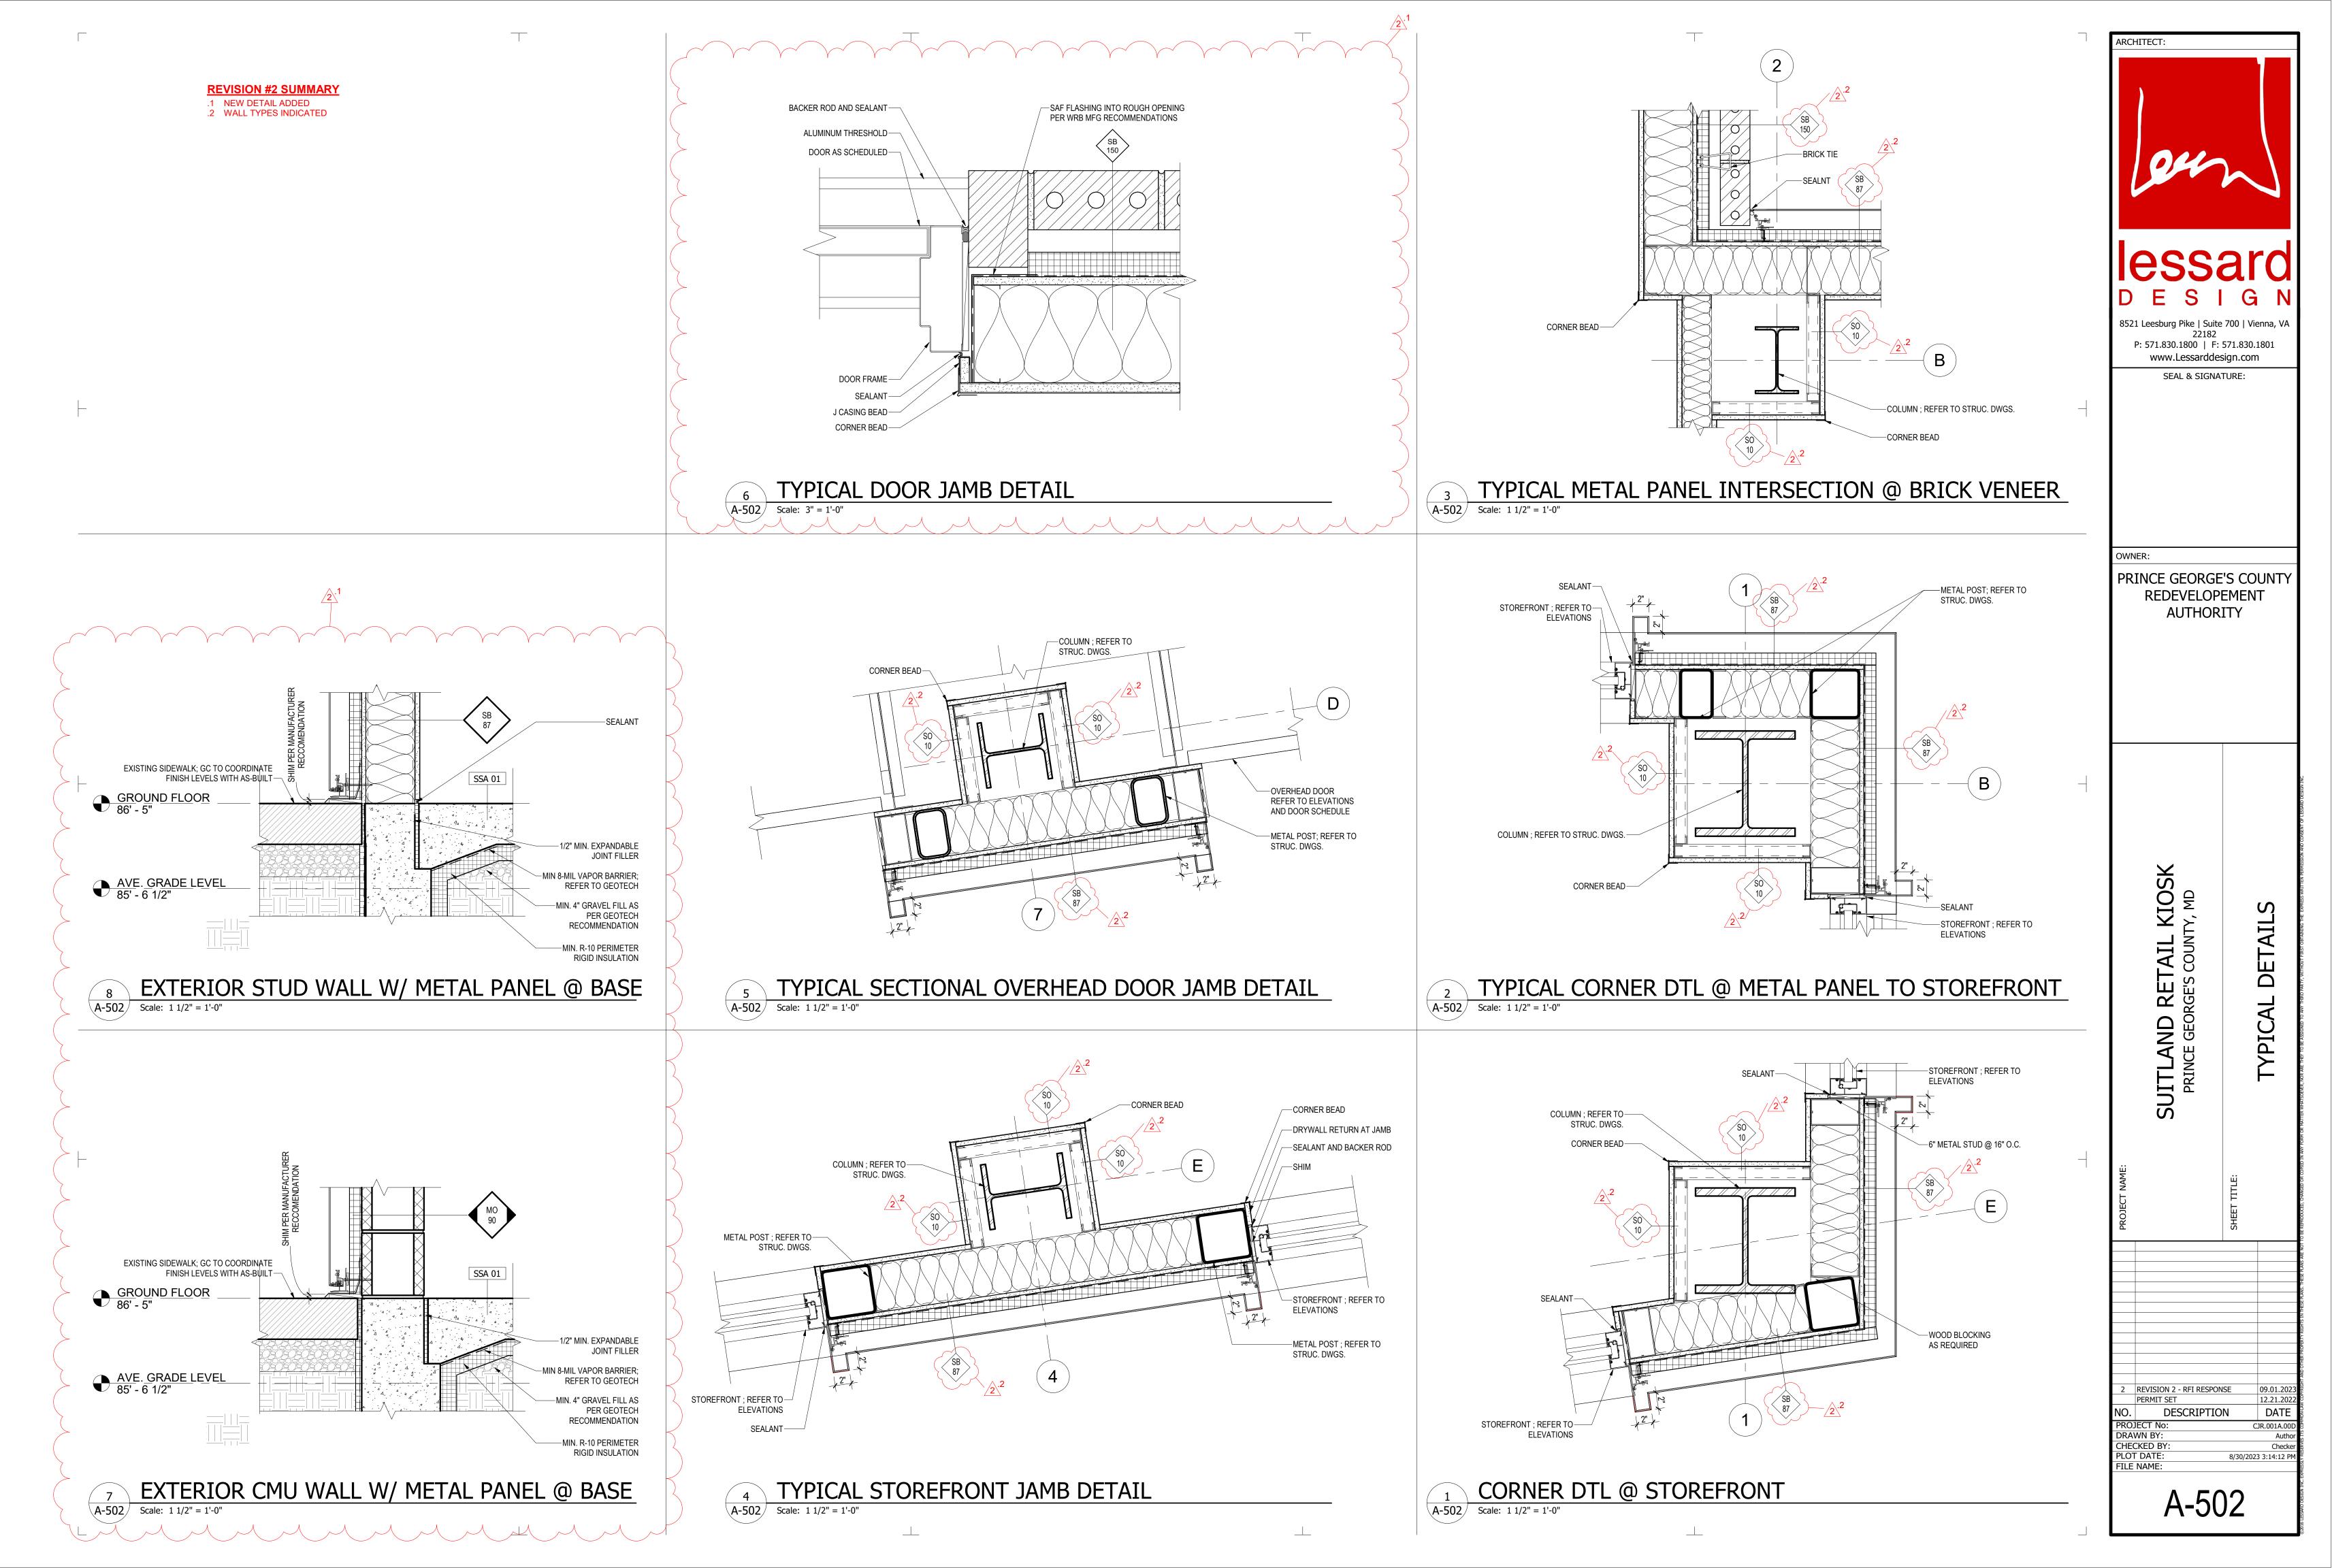









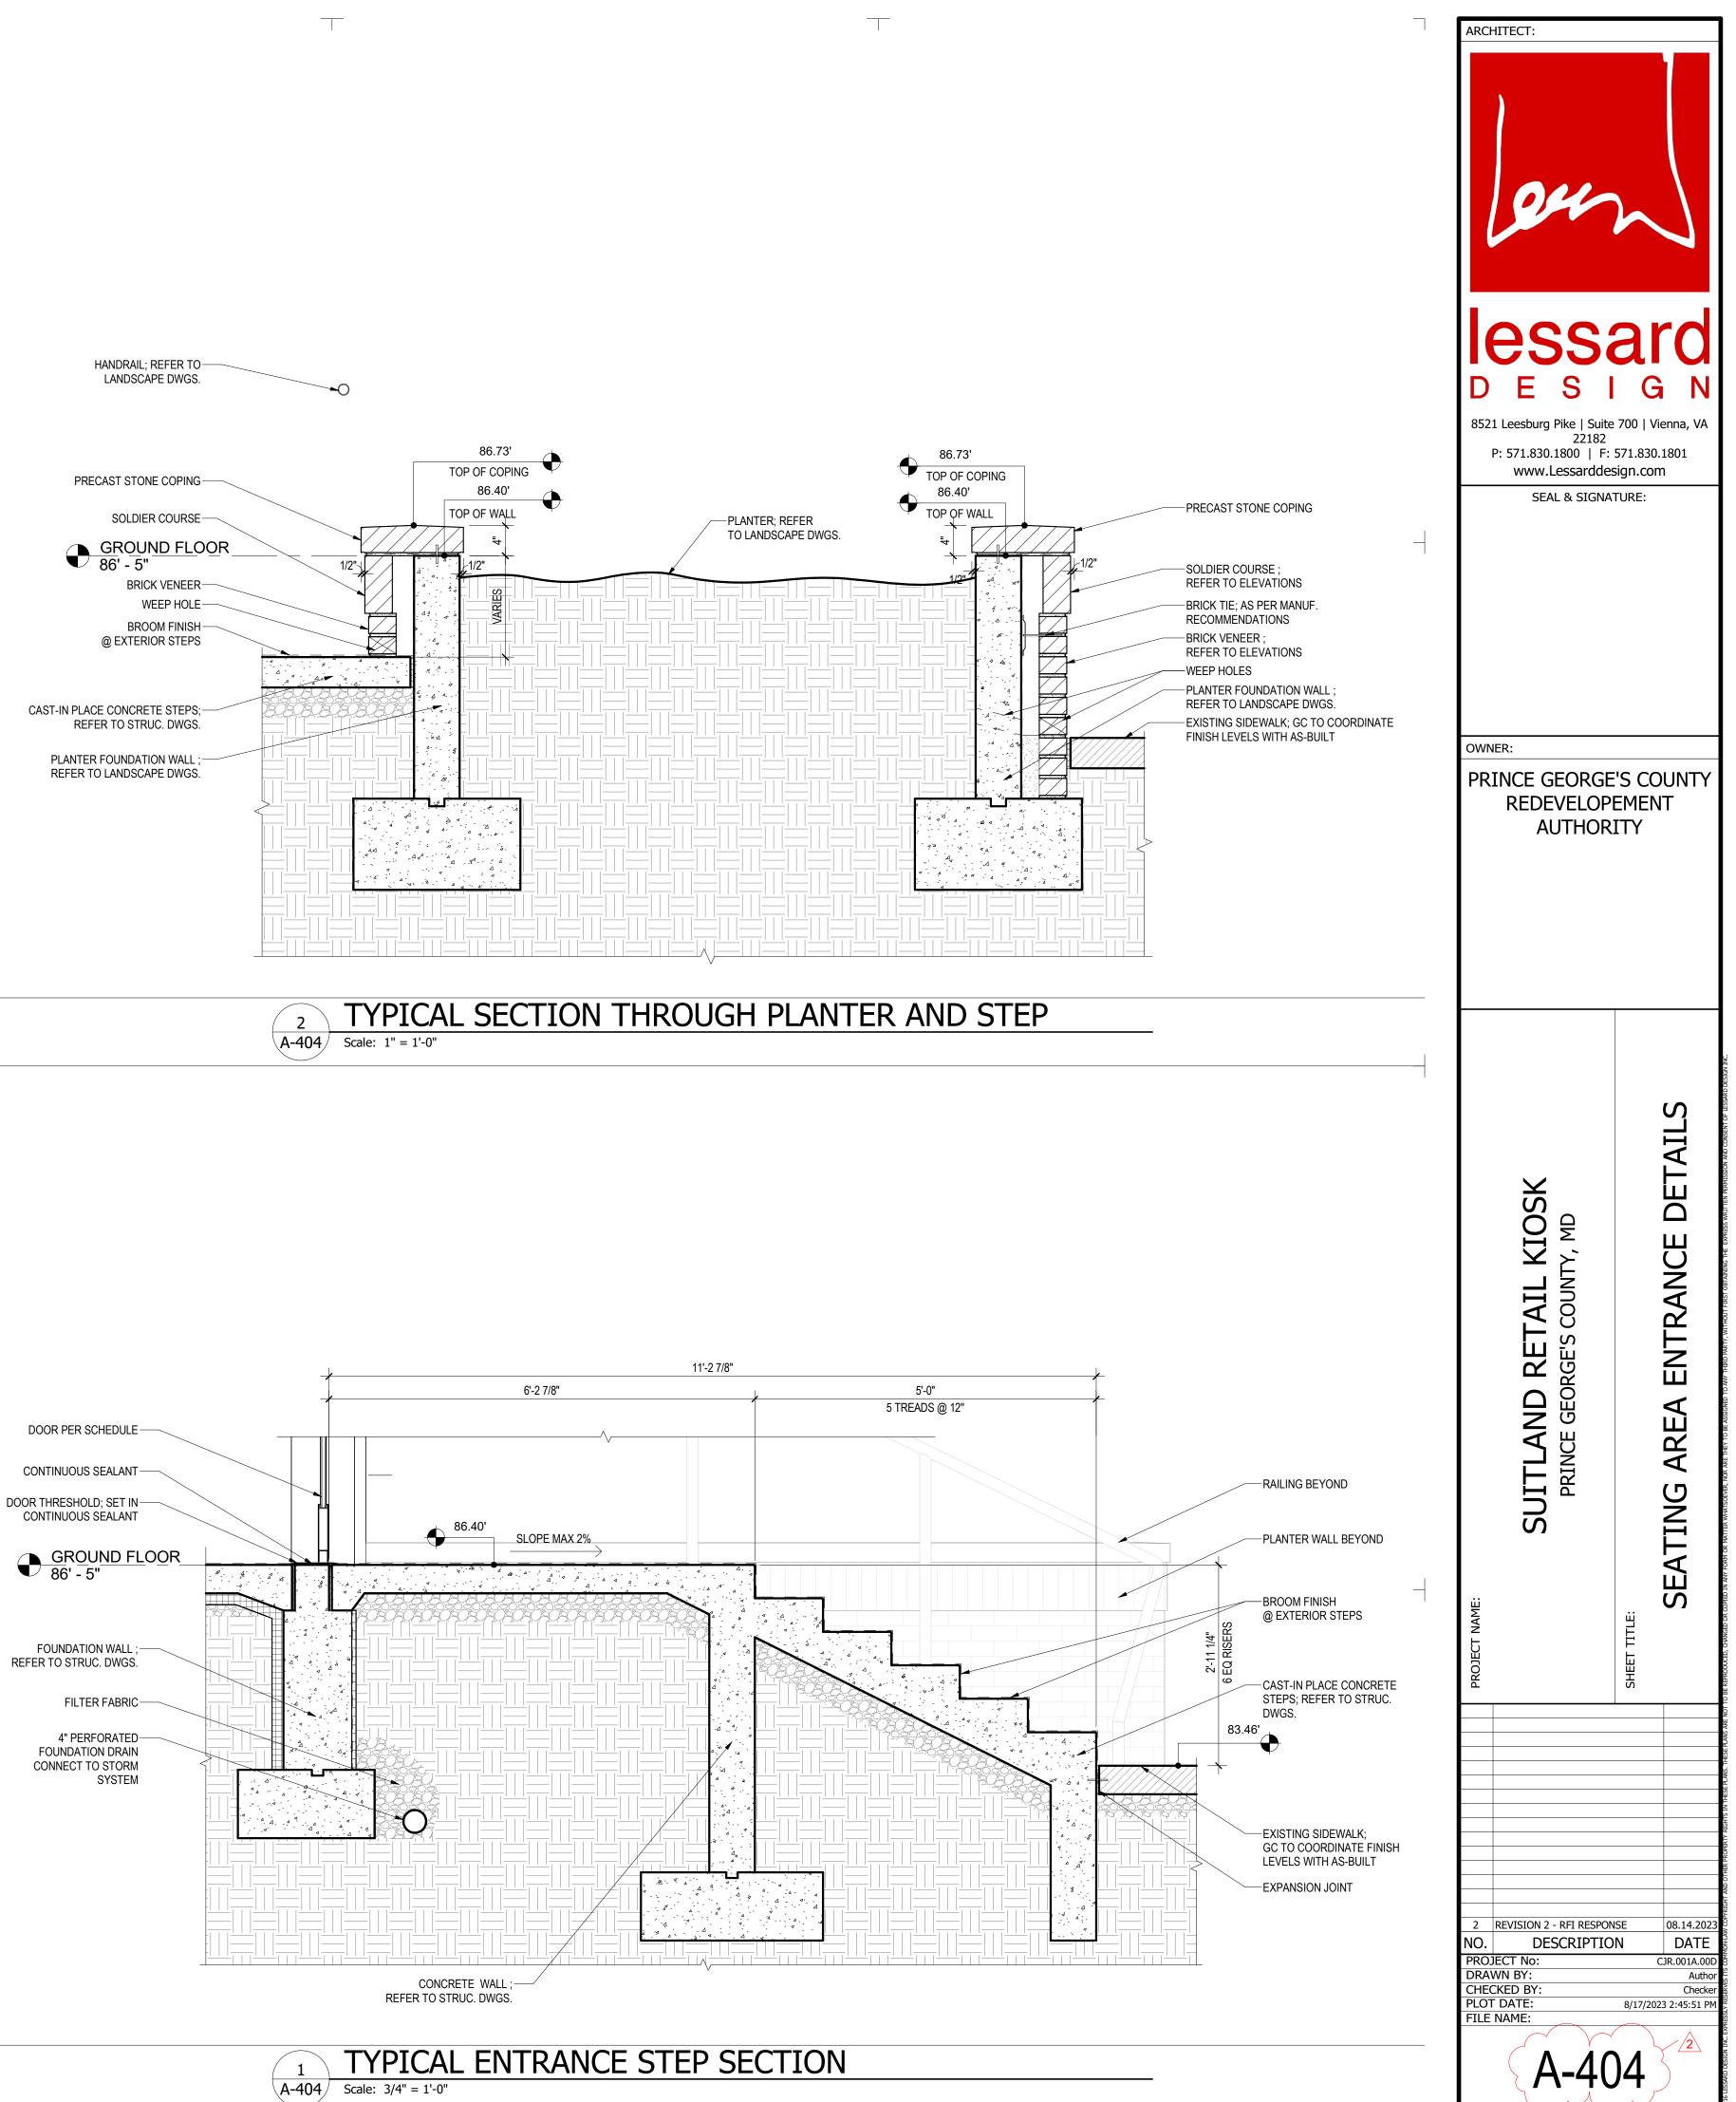


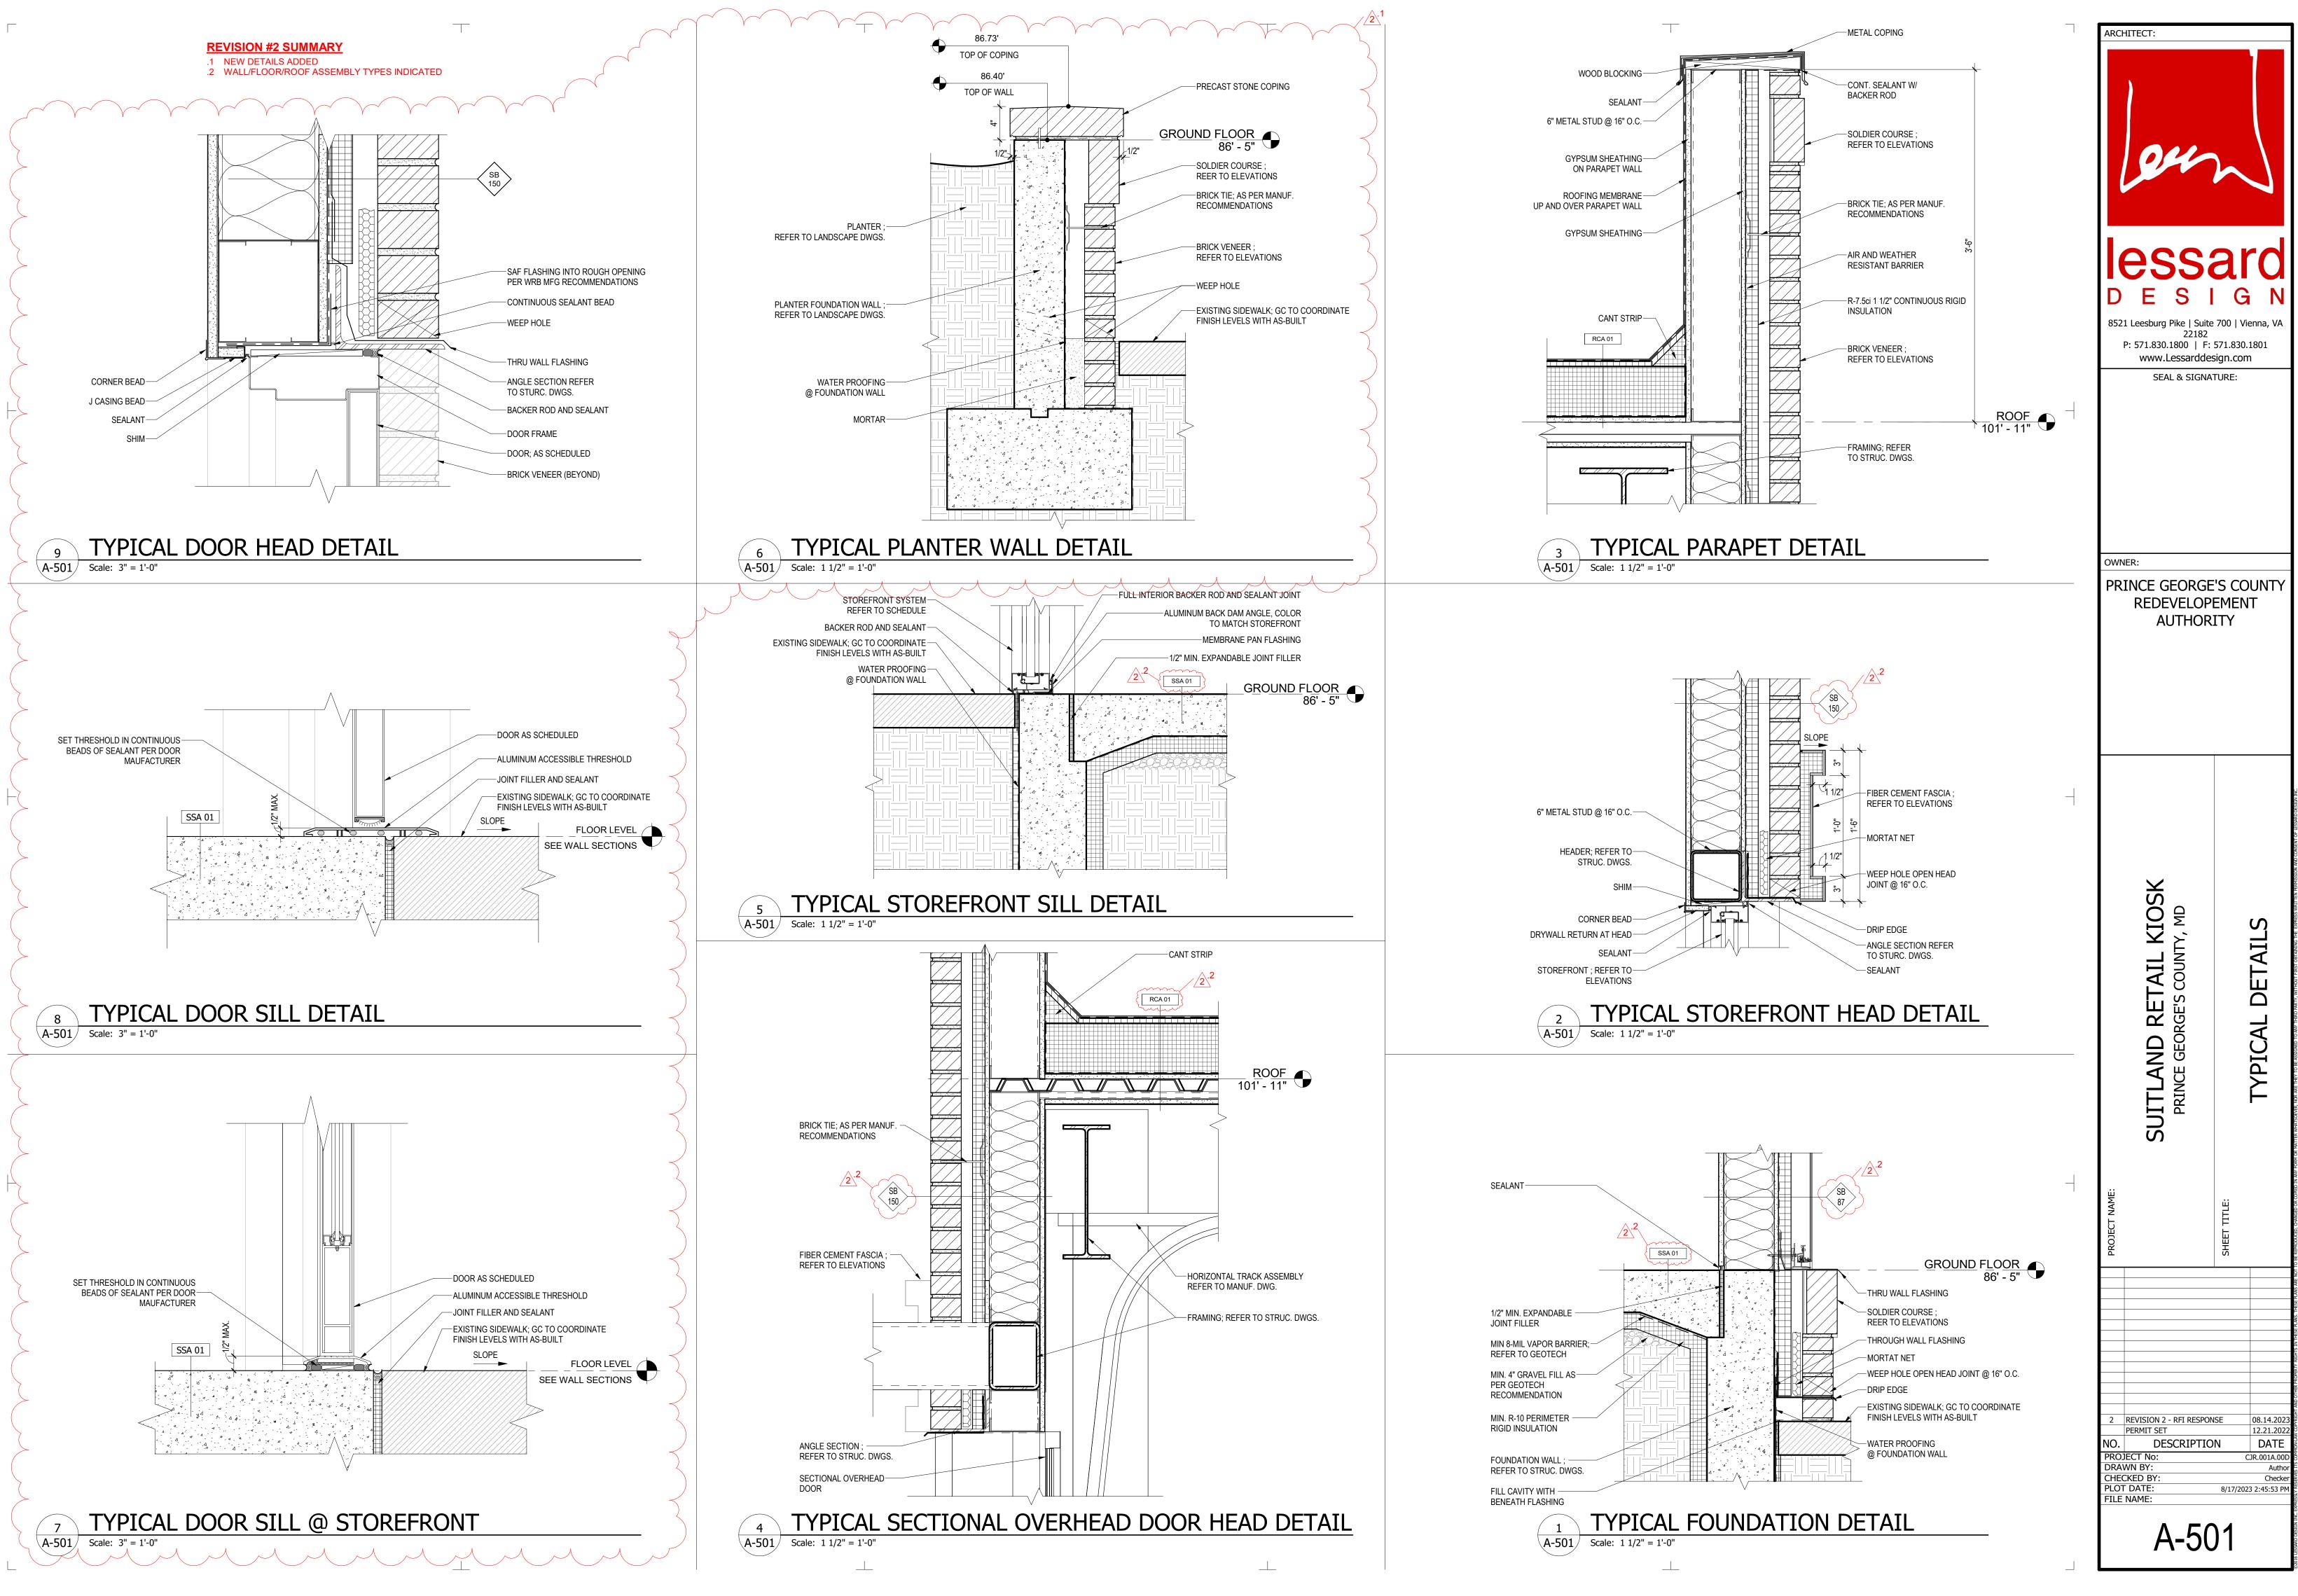


						COMMON AREAS DOOR SCHEDU	ILE											
						DOOR	FRA	ME						0	SIDF)	Ĺ		
DOOR NUMBER	LOCATION	WIDTH	HEIGHT	THICKNESS	TYPE	MATERIAL	FRAME MATERIAL	FRAME TYPE	HARDWARE SET	REMARKS	DOOR CLOSER	WEATHER STRIPPING		BOTTOM DOOR SWEEP	HINGES(PER LEAF) DOOR PUI I S(60" FA SI	Ś	WALL STOP STOREROOM LOCK	180 DEGREE HINGE
					_		1			1	1							
100A	SEATING / FOOD / PREP AREA	6' - 0"	7' - 9"	0' - 1 3/4"	D	ALUM	ALUM	F2	2, 5, 6, 14, 15, 18	PANIC HARDWARE	x	X	Х	X	4 X	,		
100B	SEATING / FOOD / PREP AREA	10'-0"	12'-0"	0' -'1 3/4"	E	SECTIONAL OVERHEAD DOOR W/ FULL VISION GLASS	MTL	-										
100C	SEATING / FOOD / PREP AREA	10'-0"	12'-0"	0' -'1 3/4"	E	SECTIONAL OVERHEAD DOOR W/ FULL VISION GLASS	MTL	-										
100D	SEATING / FOOD / PREP AREA	3' - 0"	7' - 11"	0' - 1 3/4"	С	ALUM	ALUM	F1	2, 3, 5, 6, 8, 9, 11, 18		X	х	x	x	4 X	(		
100E	SEATING / FOOD / PREP AREA	6' - 0"	7' - 11"	0' - 1 3/4"	D	ALUM	ALUM	F2	1, 2, 5, 6, 8, 14, 15, 18	PANIC HARDWARE	Х	х	X	X	4 X	(		
101	MECHANICAL	3' - 0"	7' - 0"	0' - 1 3/4"	Α	SCWD	MTL	F1	1, 3, 6, 9, 11, 18		Х				3	Х	X	
102	WOMEN RR	3' - 0"	7' - 0"	0' - 1 3/4"	Α	SCWD	MTL	F1	1, 6, 20		Х				3	Х	X	
103	MEN RR	3' - 0"	7' - 0"	0' - 1 3/4"	А	SCWD	MTL	F1	1, 6, 20		Х				3	Х	X	
104	JANITOR CLOSET	3' - 0"	7' - 0"	0' - 1 3/4"	Α	SCWD	MTL	F1	1, 3, 5, 7			Х	Х	Х	3			
105	CORRIDOR	6' - 0"	7' - 0"	0' - 1 3/4"	В	SCWD	MTL	F2	1, 3, 5, 6, 15, 18			Х	Х	Х	3			
106	TRASH	3' - 3"	7' - 0"	0' - 1 3/4"	Α	SCWD	MTL	F1	1, 3, 5, 7			Х	Х	Х	3			
107	KITCHEN	3' - 0"	7' - 0"	0' - 1 3/4"	А	SCWD	MTL	F1	1, 6, 19			Х	Х	Х	3			
108	OFFICE	3' - 0"	7' - 0"	0' - 1 3/4"	Α	SCWD	MTL	F1	1, 3, 6, 9, 11, 18			Х	Х	Х	3			


# DOOR TYPE

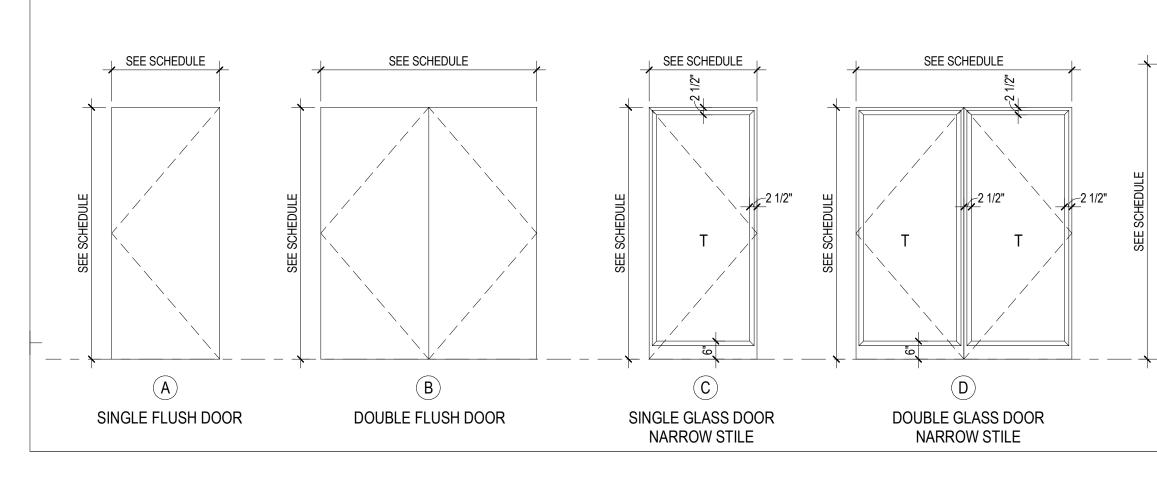

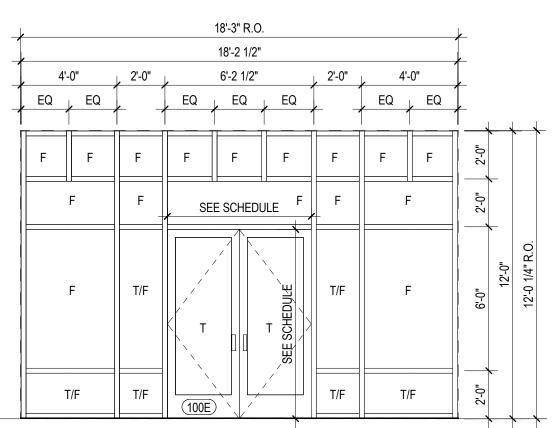

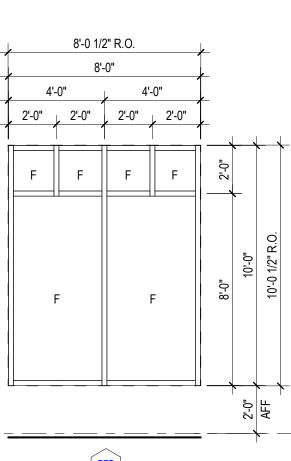

SE6

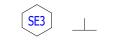


# DOOR FRAME TYPE


-4 1/2"


2'

F1

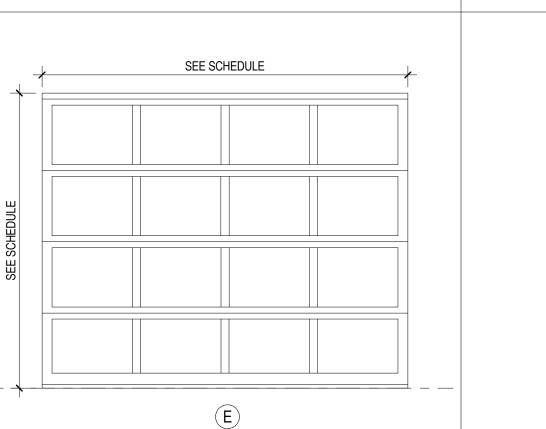

OVERHEAD DOOR AS PER MANUFACTURER

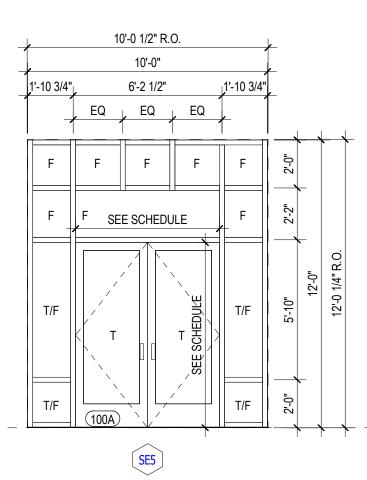

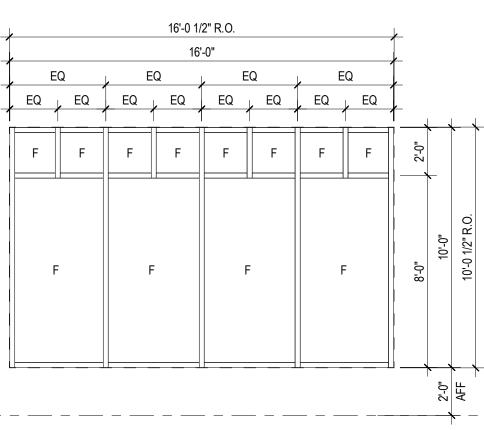



NOTE:

2"____

1. ALL EXTERIOR HOLLOW METAL FRAMES ARE WELDED. 2. KNOCK-DOWN FRAMES ARE ACCEPTABLE FOR INTERIOR OPENINGS IN ASSEMBLIES OF 1-HR RATING OR LESS. WELDED FRAMES ARE REQUIRED FOR OPENINGS IN ALL OTHER ASSEMBLIES

F2


<u>_____.2</u>

86.40'


86.40'


4 1/2"

FIN FLOOR

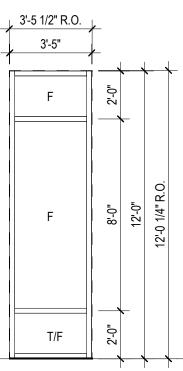

SE4

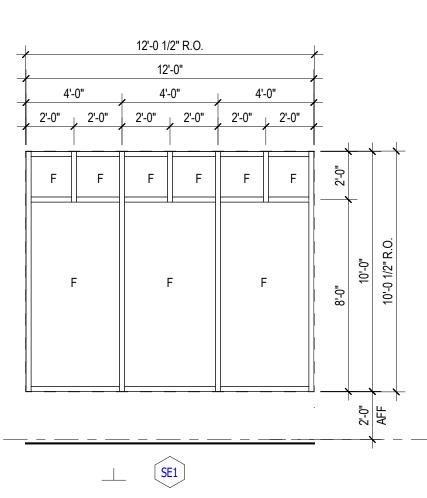

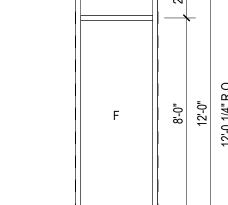



### DOOR SCHEDULE GENERAL NOTES

KICK-DOWN HOLD KICKPLATE (12" |

EN ОР

- XX X X X X X X X X X X

REFER TO ELEVATIONS ON A-200 SERIES SHEET FOR STOREFRONT & SECTIONAL OVERHEAD DOOR BASIS OF DESIGN (BOD).

- DIMENSIONS INDICATED ON PLANS AND SCHEDULES ARE NOMINAL, COORDINATE PRIOR TO FABRICATION AND CONSTRUCTION.
- PROVIDE WEATHERPROOFING SEALS AT EXTERIOR DOORS.
- COORDINATE DOOR FRAME SIZE WITH DOOR SIZE AND WITH WALL/PARTITION THICKNESS SHOW IN DOOR SCHEDULE.
- PROVIDE A MINIMUM OF 3 ANCHORS PER DOOR. PROVIDE 4 ANCHORS PER JAMB FOR DOOR OVER 7'-0" HIGH.
- APPLY SEALANT AROUND THE ENTIRE FRAME PERIMETER OF ALL EXTERIOR DOOR AND INTERIOR DOOR FRAMES. SEALANT APPLICATION AT INTERIOR DOOR FRAMES SHOULD CLOSE THE GAP BETWEEN THE WALL SURFACE AND THE FRAME SHOULD NOT CREATE A COVE AT THIS JUNCTURE.
- ALL DOORS SHALL COMPLY WITH ALL APPLICABLE CODES AND REGULATIONS.
- DOOR ROUGH OPENING DIMENSIONS TO BE VERIFIED WITH MANUFACTURER.
- NON-ACCESSIBLE BUILDING ENTRANCES MUST HAVE DIRECTIONAL SIGNAGE DIRECTING PEOPLE TO THE CLOSEST ACCESSIBLE ENTRANCE. DIRECTIONAL SIGNAGE MUST HAVE INTERNATIONAL SYMBOL OF ACCESSIBILITY.
- 10. REFER TO SHEET G-030 FOR FENESTRATION VALUES.

### LEGEND FOR EXTERIOR WINDOWS, DOORS AND STOREFRONTS

F	-	FIXED PANEL
SH	-	SINGLE HUNG WINDOW
TD	-	TERRACE DOOR
Т	-	TEMPERED GLASS
SP	-	SPANDREL GLASS
L	-	ALUMINUM LOUVER
S	-	SCREENED FRAME
FG	-	FROSTED GLASS
MP	-	METAL PANEL
TSP	-	TEMPERED SPANDREL PANEL

DOOR HARDWARE LEGEND								
NO.	HARDWARE	NO.	HARDWARE					
1	HINGE	13	FLUSHBOLT					
2	SPRING HINGE	14	EXIT DEVICE					
3	LOCKSET (LEVER HANDLE)	15	MAGNETIC LOCK					
4	LATCHSET (LEVER HANDLE)	16	KICK PLATE					
5	CLOSER	17	PUSH/PULL HANDLE					
6	STOP	18	PERIMETER GASKETING					
7	SILL	19	PASSAGE LOCKSET					
8	ADA SILL	20	PRIVACY LOCKSET (PUSH BUTTON TYPE)					
9	DOOR SWEEP	21	DUMMY TRIM					
10	DEAD BOLT	22	SLIDING DOOR PULL					
11	DEAD BOLT WITH THUMB TURN	23	SLIDING DOOR ROLLER					
12	PEEP HOLE MOUNTED AT 54" AFF. (44" AFF FOR ACCESSIBLE UNITS)	24	BARN DOOR HARDWARE SET					

<u>)</u>.1

### **REVISION #1 SUMMARY**

.1 DOOR HARDWARE INFORMATIONS ADDED .2 ROUGH OPENING DIMENSION ADDED AND GLASS TYPE COORDINATED WITH CODE

/E	D E 8521 Leesburg F P: 571.830.1 www.Le	Vike   Suite 700   V 22182 800   F: 571.830 essarddesign.co	<b>X</b> /ienna, VA 0.1801
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	PROJECT NAME: SUITLAND RETAIL KIOSK	PRINCE GEORGE'S COUNTY, MD	SCHEDULE AND DETAILS
	PROJE	SHEET	
	1 REVISION 1 PERMIT SET NO. DES PROJECT NO: DRAWN BY: CHECKED BY: PLOT DATE: FILE NAME:	CRIPTION 8/17/20	04.14.2023 12.21.2022 DATE CJR.001A.00D Author Checker 023 2:45:58 PM